


TWO STORY SINGLE FAMILY HOME HAWAII LOA RIDGE REVIEW 06/20/2023


912 IKENA CIR, HONOLULU, HI 96821 HAWAII LOA RIDGE LOT 21 PHASE VIII

TMK: 37020030

SYMBOLS LEGEND

WINDOW NUMBEF

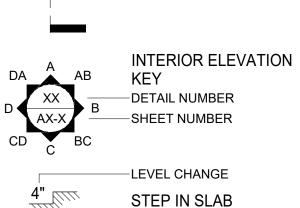

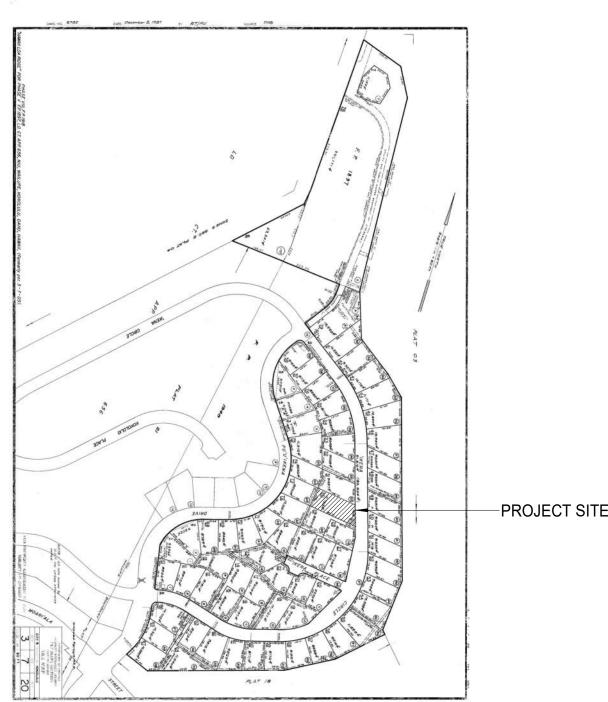

PLAT MAP

GENERAL NOTES

ALL WORK SHALL BE DONE IN ACORDANCE WITH AND CONFORM TO THE FOLLOWING BUILDING CODES:

THE CITY & COUNTY OF HONOLULU BUILDING CODE

SPOT ELEVATION

- REVISED ORDINANCE OF HONOLULU (ROH) CHAPTER 16 BUILDING CODE
- AND CHAPTER 21 LAND USE ORDINANCE. THE CURRENTLY APPROVED 2012 INTERNATIONAL RESIDENTIAL
- **BUILDING CODE (IRC)**
- 2012 UNIFORM PLUMBING CODE & ROH CHAPTER 19
- NATIONAL ELECTRIC CODE (NEC) 2017 & ROH CHAPTER 17
- HONOLULU FIRE DEPARTMENT NFPA-1 2015 & ROH CHAPTER 20 • THE HAWAII ENERGY BUILDING CODE IECC 2015 & ROH CHAPTER 32
- **BUILDING CODE**
- ANY OTHER APPLICABLE COUNTY STATE OR FEDERAL REGULATIONS.
- 1. THE CONTRACTOR SHALL VERIFY AND BE RESPONSIBLE FOR ALL DIMESIONS AND CONDITIONS AT THE SITE AND SHALL NOTIFY PLAN MAKER OF ANY DISCREPENCIES BETWEEN ACTUAL CONDITIONS AND INFORMATION SHOWN ON THE DRAWINGS BEFORE PROCEEDING WITH THE WORK. THIS SHALL INCLUDE THE LOCATION AND DIMENSIONS OF WALLS, OPENINGS, CABINETS, EMBEDDED AND ATTACHED ITEMS, BEFORE ORDERING WINDOWNS, DOORS, CABINETS AND OTHER BUILT IN FIXTURES, ETC. CONTACTOR SHALL TAKE FIELD-MEASUREMENTS AND CROSS-CHECK ALL DRAWINGS.
- 2. CONTRACTOR TO CONTACT THE CITY AND COUNTY OF HONOLULU BUILDING INSPECTORS 48 HOURS PRIOR TO THE REQUIRED INSPECTION.
- 3. CONTRACTOR IS RESPONSILE TO MAINTAIN A CLEAN AND DEBRIS FREE JOBSITE THROUGHOUT THE DURATION OF THE PROJECT. ALLTRASH AND DEBRIS TO BE DISPOSED OF TO PROPER AND APPROVED DISPOSAL SITES
- 4. CONTRACTOR TO MAINTAIN THE 'OSHA' STANDARDS OF SAFETY THROUGHOUT THE JOB-SITE FOR THE DURATION OF THE PROJECT

ROUGH FRAMING

ALL ROUGH FRAMING TO BE TREATED LUMBER (SEE LUMBER NOTES BELOW) PROVIDE FIRE BLOCKING AS PER THE UBC SECTION 708. PROVIDE SUPPORT BLOCKING BEHIND ALL LIGHT FIXTURES J-BOXES, MIRRORS AND CABINETS. PROVIDE COMPLETE TERMITE AND DECAY PROTECTION PER THE CURRENT INTERNATIONAL RESIDENTIAL CODE (IRC) OF THE CITY & COUNTY OF HONOLULU PER SECTION R319 AS AMMENDED.

ALL FRAMING LUMBER SHALL BE DOUGLAS FIR/LACH, TERMITE TREATED WOOD. FINISH AND TRIM SHALL BE NOTCHED FOR HARDWARE AS REQUIRED TO PROVIDE A SNUG FIT AT ALL JOINTS. SEE FINISH SCHEDULE FOR TRIM.

INTERIOR SHEATHING

ALL INTERIOR WALL & CEILING SHEATHING TO BE 1/2" STANDARD GYPSUM BOARD W/ GREENBOARD TO BE USED IN BATH ROOM AREAS. FOR ALL DRYWALL CORNERS USE VINYL 90 DEGREES CORNER BEADING. ALL DRYWALL WALLS TO BE SMOOTH FINISHED. SHOWER STALLS TO BE SHEATHED W/ DURA-ROCK. USE GALVANISED OR STAINLESS STEEL FASTENERS THROUGHOUT.

ALL PLUMBING WORK SHALL BE PERFORMED IN ACCORDANCE WITH THE 2012 UNIFORM PLUMBING CODE & ROH CHAPTER 19 BUILDING CODE BY A LICENSED PLUMBING CONTRACTOR. ALL PLUMBING FIXTURES SHALL BE SELECTED BY THE OWNERS OR DESIGNATED REPRESENTATIVES AND INSTALLED BY THE PLUMBING CONTRACTOR.

ALL ELECTRICAL WORK SHALL BE PERFORMED IN ACCORDANCE WITH THE NATIONAL ELECTRIC CODE (NEC) 2017 & ROH CHAPTER 17 BUILDING CODE BY A LICENSED ELECTRICAL CONTRACTOR. ALL LIGHT FIXTURES SHALL BE APPROVED BY THE OWNERS OR DESIGNATED REPRESENTATIVES PRIOR TO INSTALLATION BY THE ELECTRICAL CONTRACTOR. THE SMOKE DETECTORS SHALL BE U.L. APPROVED AND HARD-WIRED WITH BATTERY BACK-UP POWER.

> THE METER FOR THIS RESIDENCE DOES NOT SERVE AUTOMATIC FIRE SPRINKLER SYSTEM OR IRRIGATION.

ALL NEW FIXTURES TO BE LOW FLOW

ABBREVIATIONS


ABOVE FINISH FLOOR **ELECTRICA EXTERIOR FLOOR GLULAM BEAM INTERIOR** JUNCTION LAVATORY LAUNDRY TRAY LT MTL **METAL** O.C. ON CENTER O/ **OVER** PA **PLANTER** PROPERTY LINE REFRIGERATOR ROOM **SAFETY GLASS**

SHEET INDEX

001	PROJECT INFO AND SITE PLAN	C
A001	SURVEY	1
A002	PLOT PLAN AND NOTES	1
A003	SITE SECTIONS	1
A004	FIRST FLOOR PLAN	1
A005	SECOND FLOOR PLAN	1
A006	ROOF PLAN	1
A007	EXTERIOR ELEVATIONS	1
800A	EXTERIOR ELEVATIONS	1
A009	BUILDING SECTIONS	1
A010	BUILDING SECTIONS	1
A011	SCHEDULES	1
A013	ENLARGED PLANS AND ELEVATIONS	1
A015	DETAILS	1
S000	STRUCTURAL NOTES	2
S001	FOUNDATION PLAN	2
S002	SECOND FLOOR FRAMING PLAN	2
S003	ROOF FRAMING PLAN	2
E001	FIRST FLOOR ELECTRICAL PLAN	3
E002	SECOND FLOOR ELECTRICAL PLAN	3
L100	PLANTING PLAN	4
L200	IRRIGATION PLAN	4
L300	PLANTING DETAILS	4
L400	IRRIGATION DETAILS	4
L500	IRRIGATION DETAILS	4

CITY AND COUNTY OF HONOLULU **REVISED ORDINANCE CHAPTER32.** HONOLULU COUNTY CODE 1990 ,AS AMENDED To the best of my knowledge, this project's design substantially conforms to the Building Energy Conservation Code for: **Building Component Systems**

VICINITY MAP

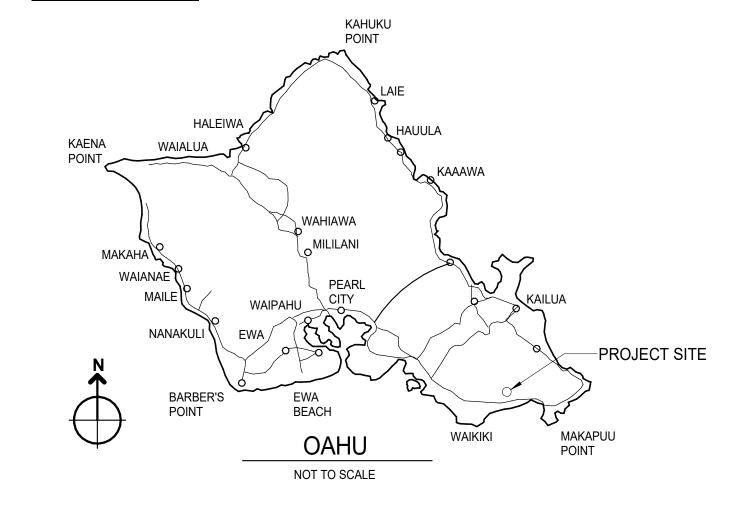

PROJECT DATA

PARKING PROVIDED

ZONING (LUO) LOT AREA ALLOWABLE LOT COVERAGE (50%)	R-7.5 11,733 SF 5,867 SF
- LEVEL 1 - LEVEL 2	632 SF 2,330 SF
- GARAGE	476 SF
TOTAL FLOOR AREA FAR (2,962 SF / 11,733 SF) TOTAL BUILDING AREA LOT COVERAGE	2,962 SF 25% 2,330 SF 19%
PARKING REQUIREMENTS: 1 PER ADDITIONAL 1000 SF	3

BUILDING CODE REQUIREMENTS FOR SPECIAL INSPECTIONS

- ☑ 1. CONCRETE ☐ 10. SPRAY-APPLIED FIREPROOFING
- ☐ 2. BOLTS INSTALLED IN CONCRETE ☐ 11. PILING, DRILLED PIERS AND CAISSONS
- ☐ 3. SPECIAL MOMENT-RESISTING
- CONCRETE FRAME ☐ 4. REINFORCING STEEL AND PRESTRESSING
- STEEL TENDONS
- ☐ 5. STRUCTURAL WELDING
- ☐ 6. HIGH-STRENGTH BOLTING
- ☐ 7. STRUCTURAL MASONRY ☐ 8. REINFORCED GYPSUM CONCRETE

- ☐ 12. SHOTCRETE
- ☐ 13. SPECIAL GRADING, EXCAVATION AND FILLING
- ☐ 14. FIRE-PROTECTION SYSTEM
- ☐ 15. SPECIAL CASES (SPECIFY)
- **☒** 17. COMPLETE LOAD PATH AND UPLIFT TIES
- **☒** 18. TERMITE PROTECTION

DUTIES AND RESPONSIBILITIES OF THE SPECIAL INSPECTOR

- 1. OBSERVE WORK ASSIGNED FOR CONFORMANCE WITH PROVIDED DESIGN DRAWINGS AND SPECIFICATIONS.
- 2. FURNISH INSPECTION REPORTS TO THE OWNER, ARCHITECT
- CONTRACTOR OF RECORD, AND OTHER OWNER-DESIGNATED PERSONS. ALL DISCREPANCIES SHALL BE BROUGHT TO THE IMMEDIATE ATTENTION OF THE ARCHITECT / CONTRACTOR FOR CORRECTION, THEN IF UNCORRECTED. TO THE PROPER DESIGN AUTHORITY AND THE BUILDING
- 3. SUBMIT FINAL SIGNED REPORT STATING WHETHER THE WORK REQUIRING SPECIAL INSPECTION WAS TO THE BEST OF THE SPECIAL INSEPECTORS KNOWDLEGE, IN CONFORMANCE WITH APPROVED PLANS AND SPECIFICATIONS AND APPLICABLE WORKMANSHIP PROVISIONS OF THE BUILDING CODE. ALSO, INDICATE THE TYPE OF WORK THAT WAS INSPECTED. THIS REPORT SHALL BE SUBMITTED PRIOR TO THE ISSUANCE OF THE CERTIFICATE OF OCCUPANCY.



001

LICENSED

PROFESSIONAL

ARCHITECT

ME OR UNDER MY SUPERVISION AND CONSTRUCTION OF THIS

PROJECT WILL BE UNDER MY

EXPIRATION DATE: 04/30/2024

Description

OBSERVATION.

Issue Dates:

Scale:

As indicated

06/20/2023

PROJECT

INFO AND

SITE PLAN

★ \ NO. AR-

SOLID CORE

SQUARE FEET

TOWEL BAR

VERIFY IN FIELD

WATER CLOSET

WATER HEATER

UNLESS NOTED OTHERWISE

SCHEDULE

SIMILAR

STEEL

THICK

TYPICAL

SIM

STL

TYP

□ 9. INSULATING CONCRETE FILL

☒ 16. SHEATHED SHEAR WALLS AND DIAPHRAGMS

LICENSED
PROFESSIONAL
ARCHITECT
NO. AR

THIS WORK WAS PREPARED BY
ME OR UNDER MY SUPERVISION
AND CONSTRUCTION OF THIS
PROJECT WILL BE UNDER MY
OBSERVATION.

912 IKENA CIRCLE

ssue Dates:

Issue Dates:

EXPIRATION DATE: 04/30/2024

Date Description

Drawn By:
Author
Scale:


1/16" = 1'-0"


Date:

Date: 06/20/2023

SURVEY

A001

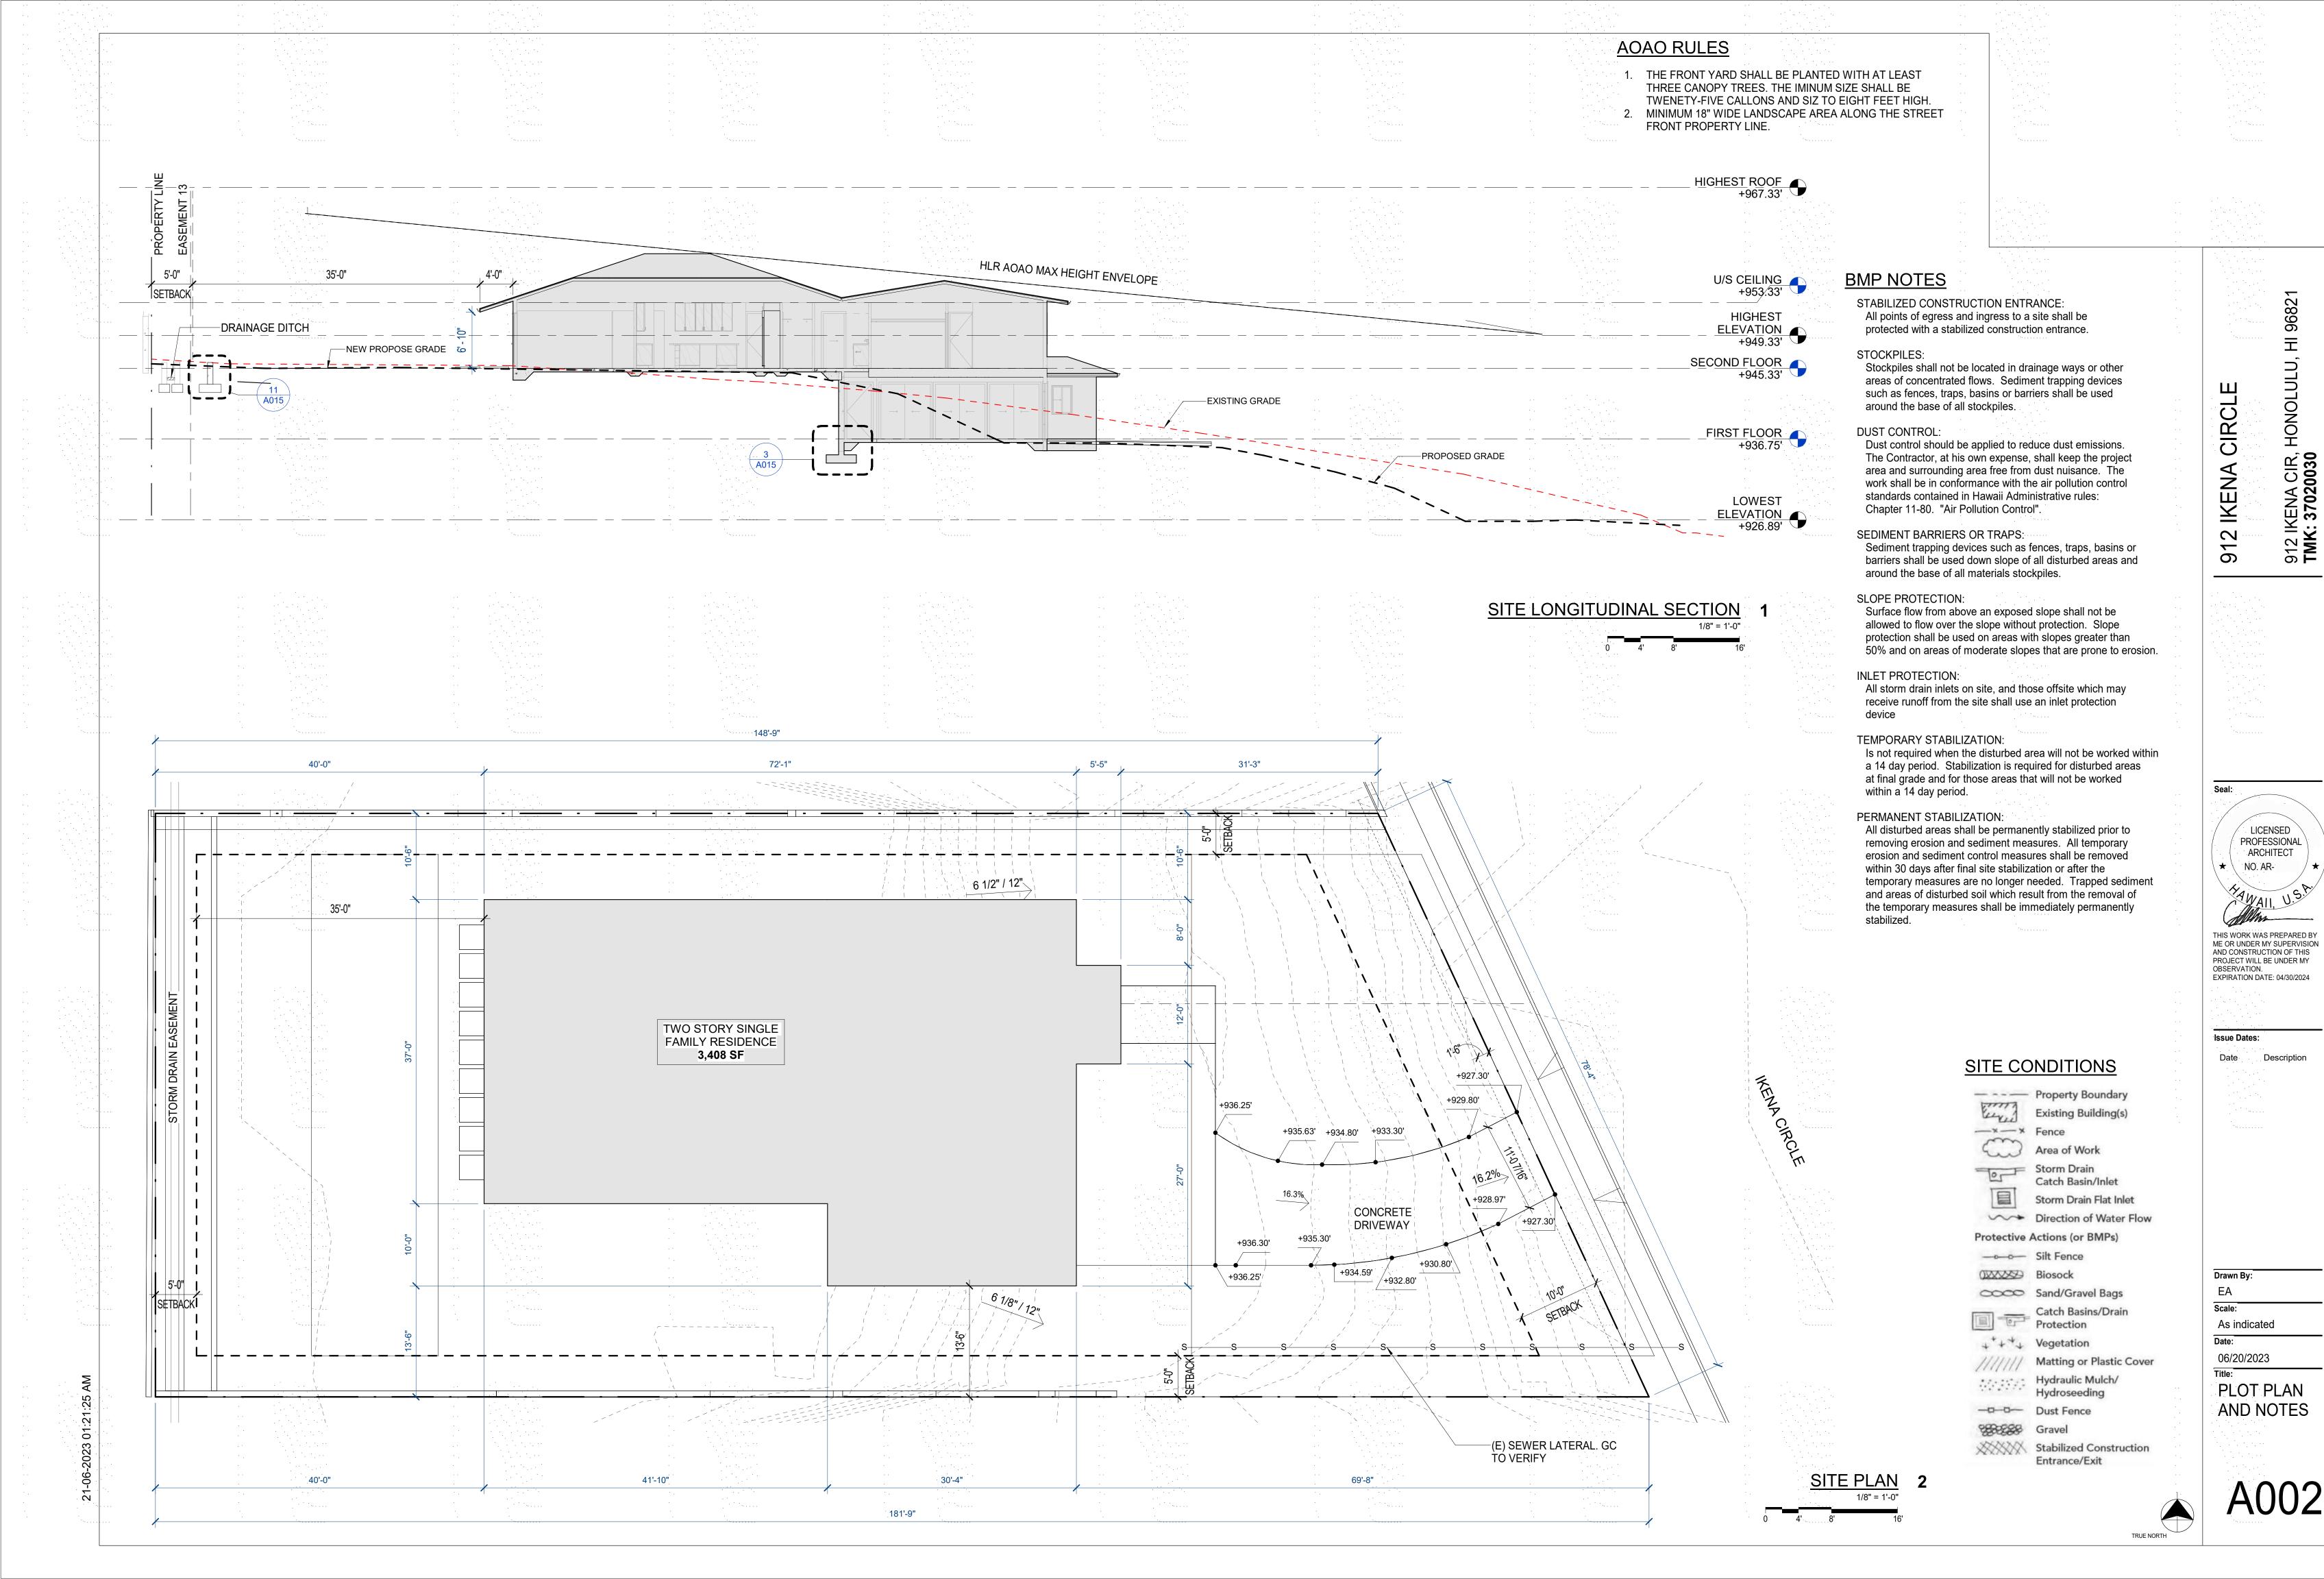

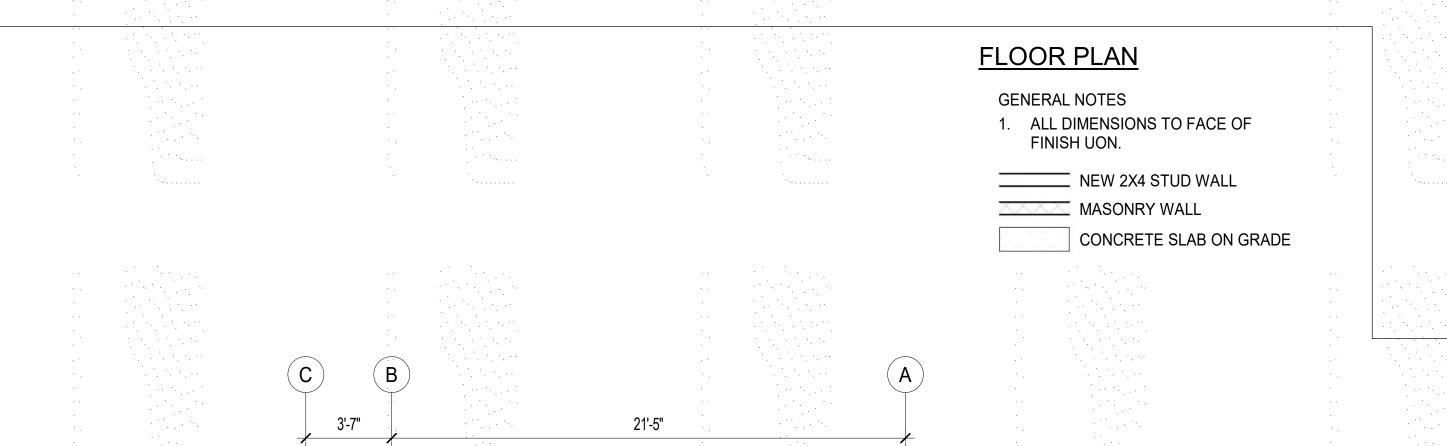

25'-4 1/2"

LIVING ROOM

505 SF

LIGHT 70 SF VENT. 35 SF

14% LIGHT / 7% VENT.

STORAGE

118

(D32)

W23

4'-0"

3'-0"

 \rightarrow D34

6'-0"

117

119 WATER HEATER A7 MM-2020-0040

25'-4 1/2"

STORAGE

. 120

18'-4 1/2"

(A007)

A009

A009


(D33)

3 1/2"

A009

(B)

(c)

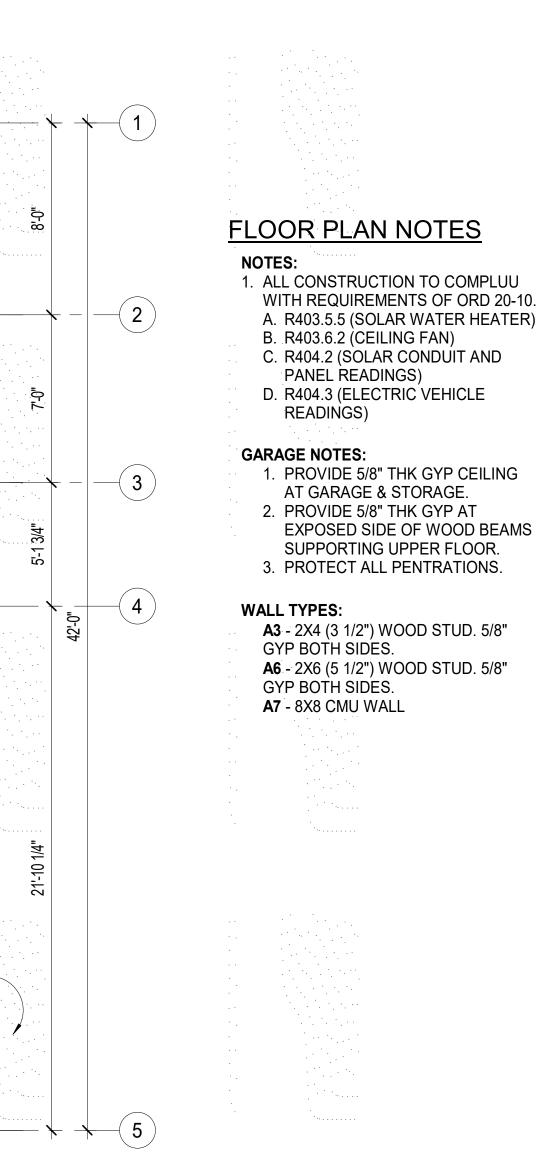

6'-0"

1 **A**007

CONCRETE DRIVEWAY

FIRST FLOOR PLAN

1/4" = 1'-0"

FLOOR PLAN NOTES

- 1. ALL CONSTRUCTION TO COMPLUU WITH REQUIREMENTS OF ORD 20-10. A. R403.5.5 (SOLAR WATER HEATER) B. R403.6.2 (CEILING FAN) C. R404.2 (SOLAR CONDUIT AND
- PANEL READINGS) D. R404.3 (ELECTRIC VEHICLE
- 1. PROVIDE 5/8" THK GYP CEILING AT GARAGE & STORAGE. 2. PROVIDE 5/8" THK GYP AT
- SUPPORTING UPPER FLOOR. 3. PROTECT ALL PENTRATIONS.

A3 - 2X4 (3 1/2") WOOD STUD. 5/8" GYP BOTH SIDES.

A6 - 2X6 (5 1/2") WOOD STUD. 5/8"

LICENSED PROFESSIONAL ARCHITECT ★ \ NO. AR-

9682

〒

HONOLULU,

912 IKENA CIR, F **TMK: 37020030**

CIRCLE

912 IKENA

ME OR UNDER MY SUPERVISION AND CONSTRUCTION OF THIS PROJECT WILL BE UNDER MY OBSERVATION. EXPIRATION DATE: 04/30/2024

Issue Dates:


Date Description


Drawn By: Scale:


As indicated


06/20/2023

FIRST FLOOR PLAN

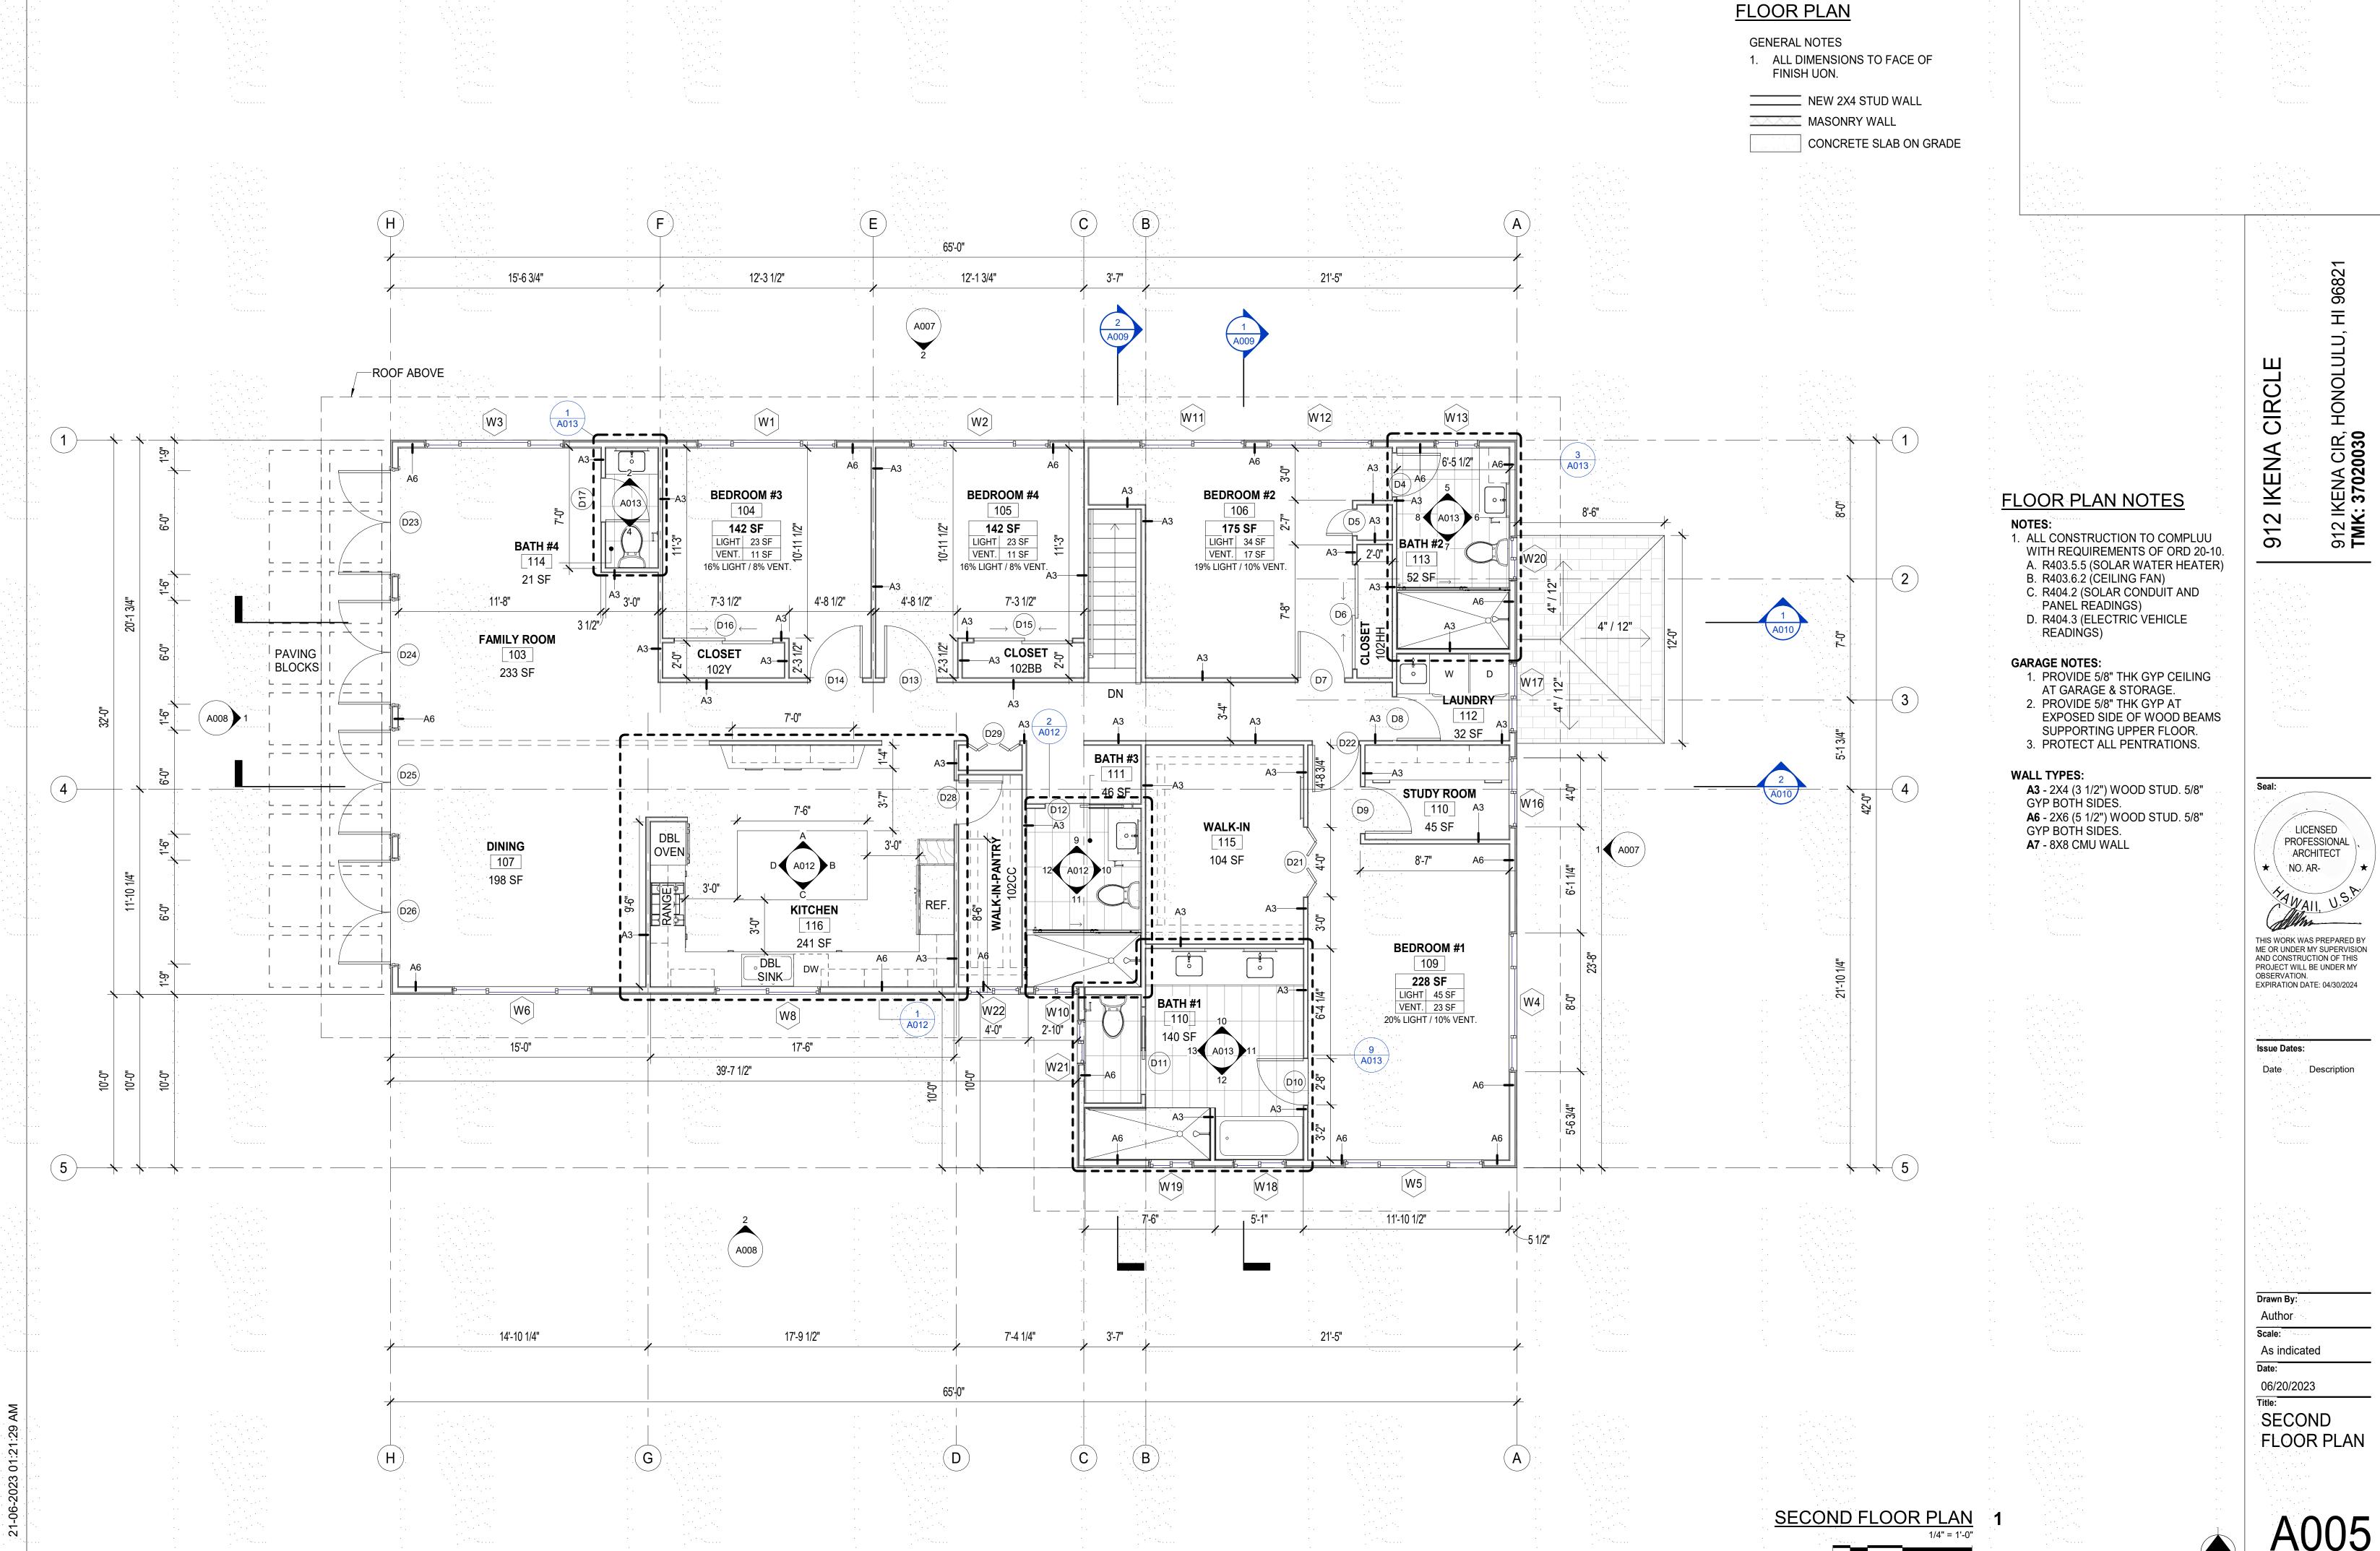

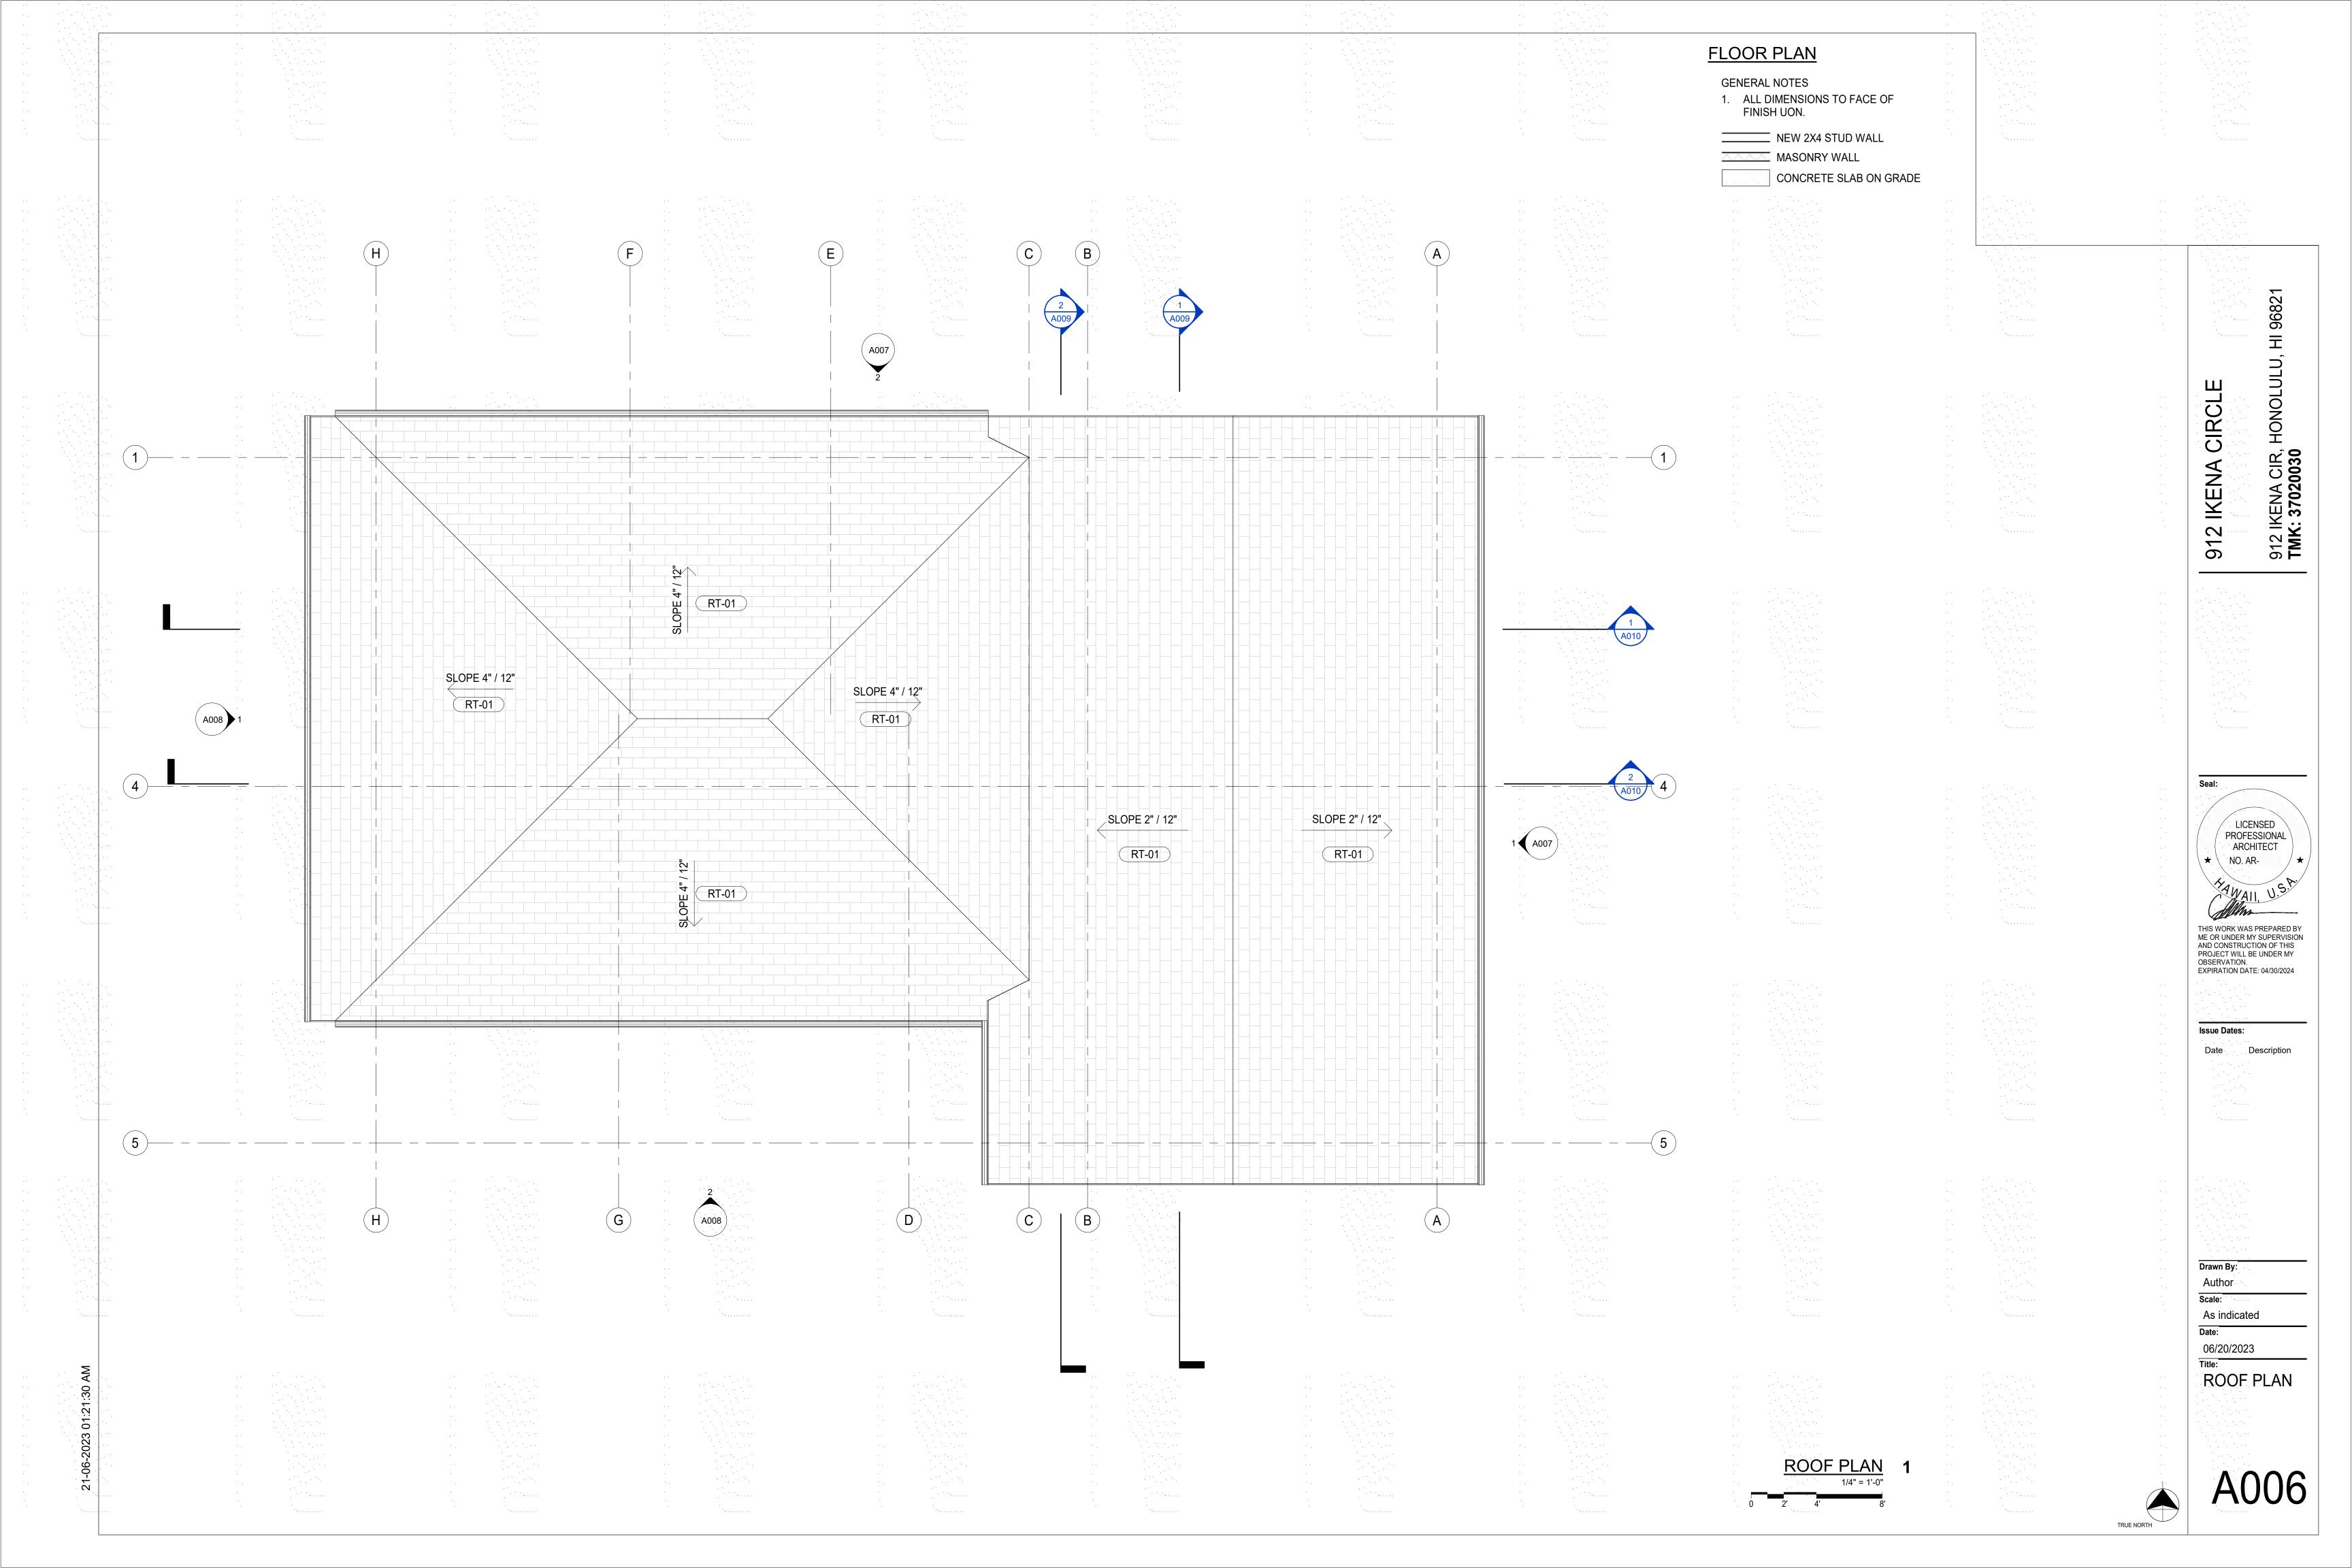

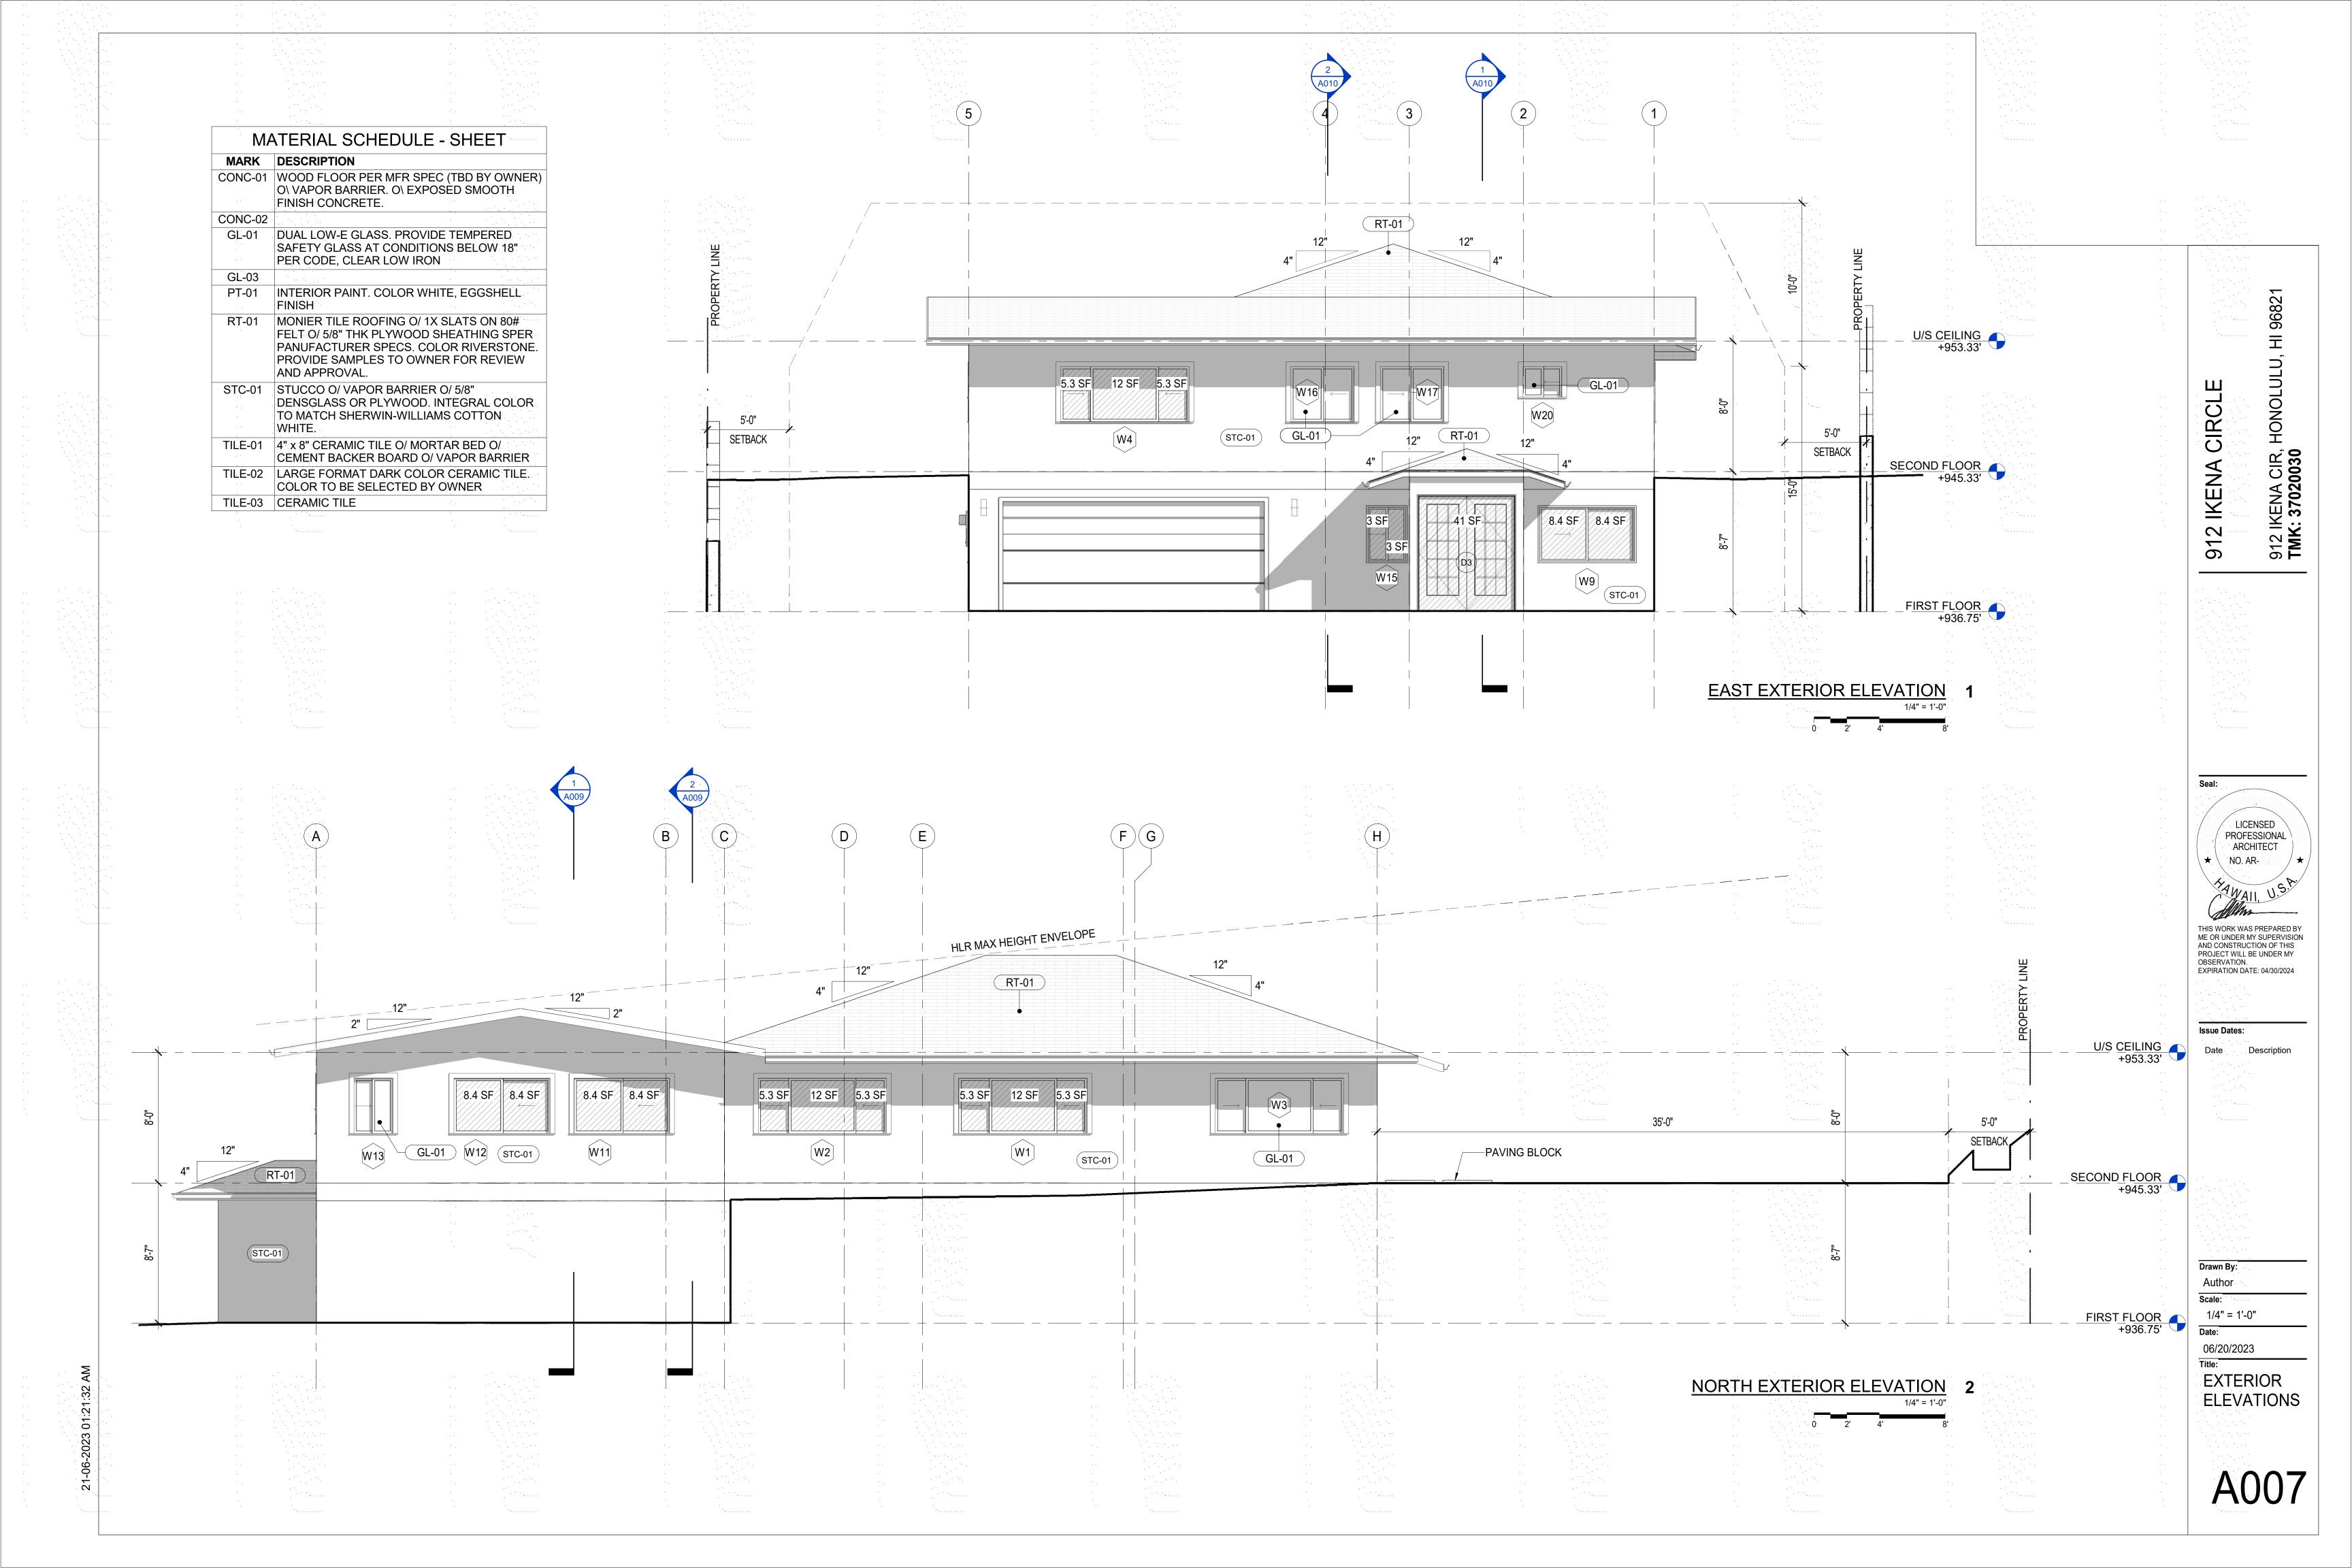

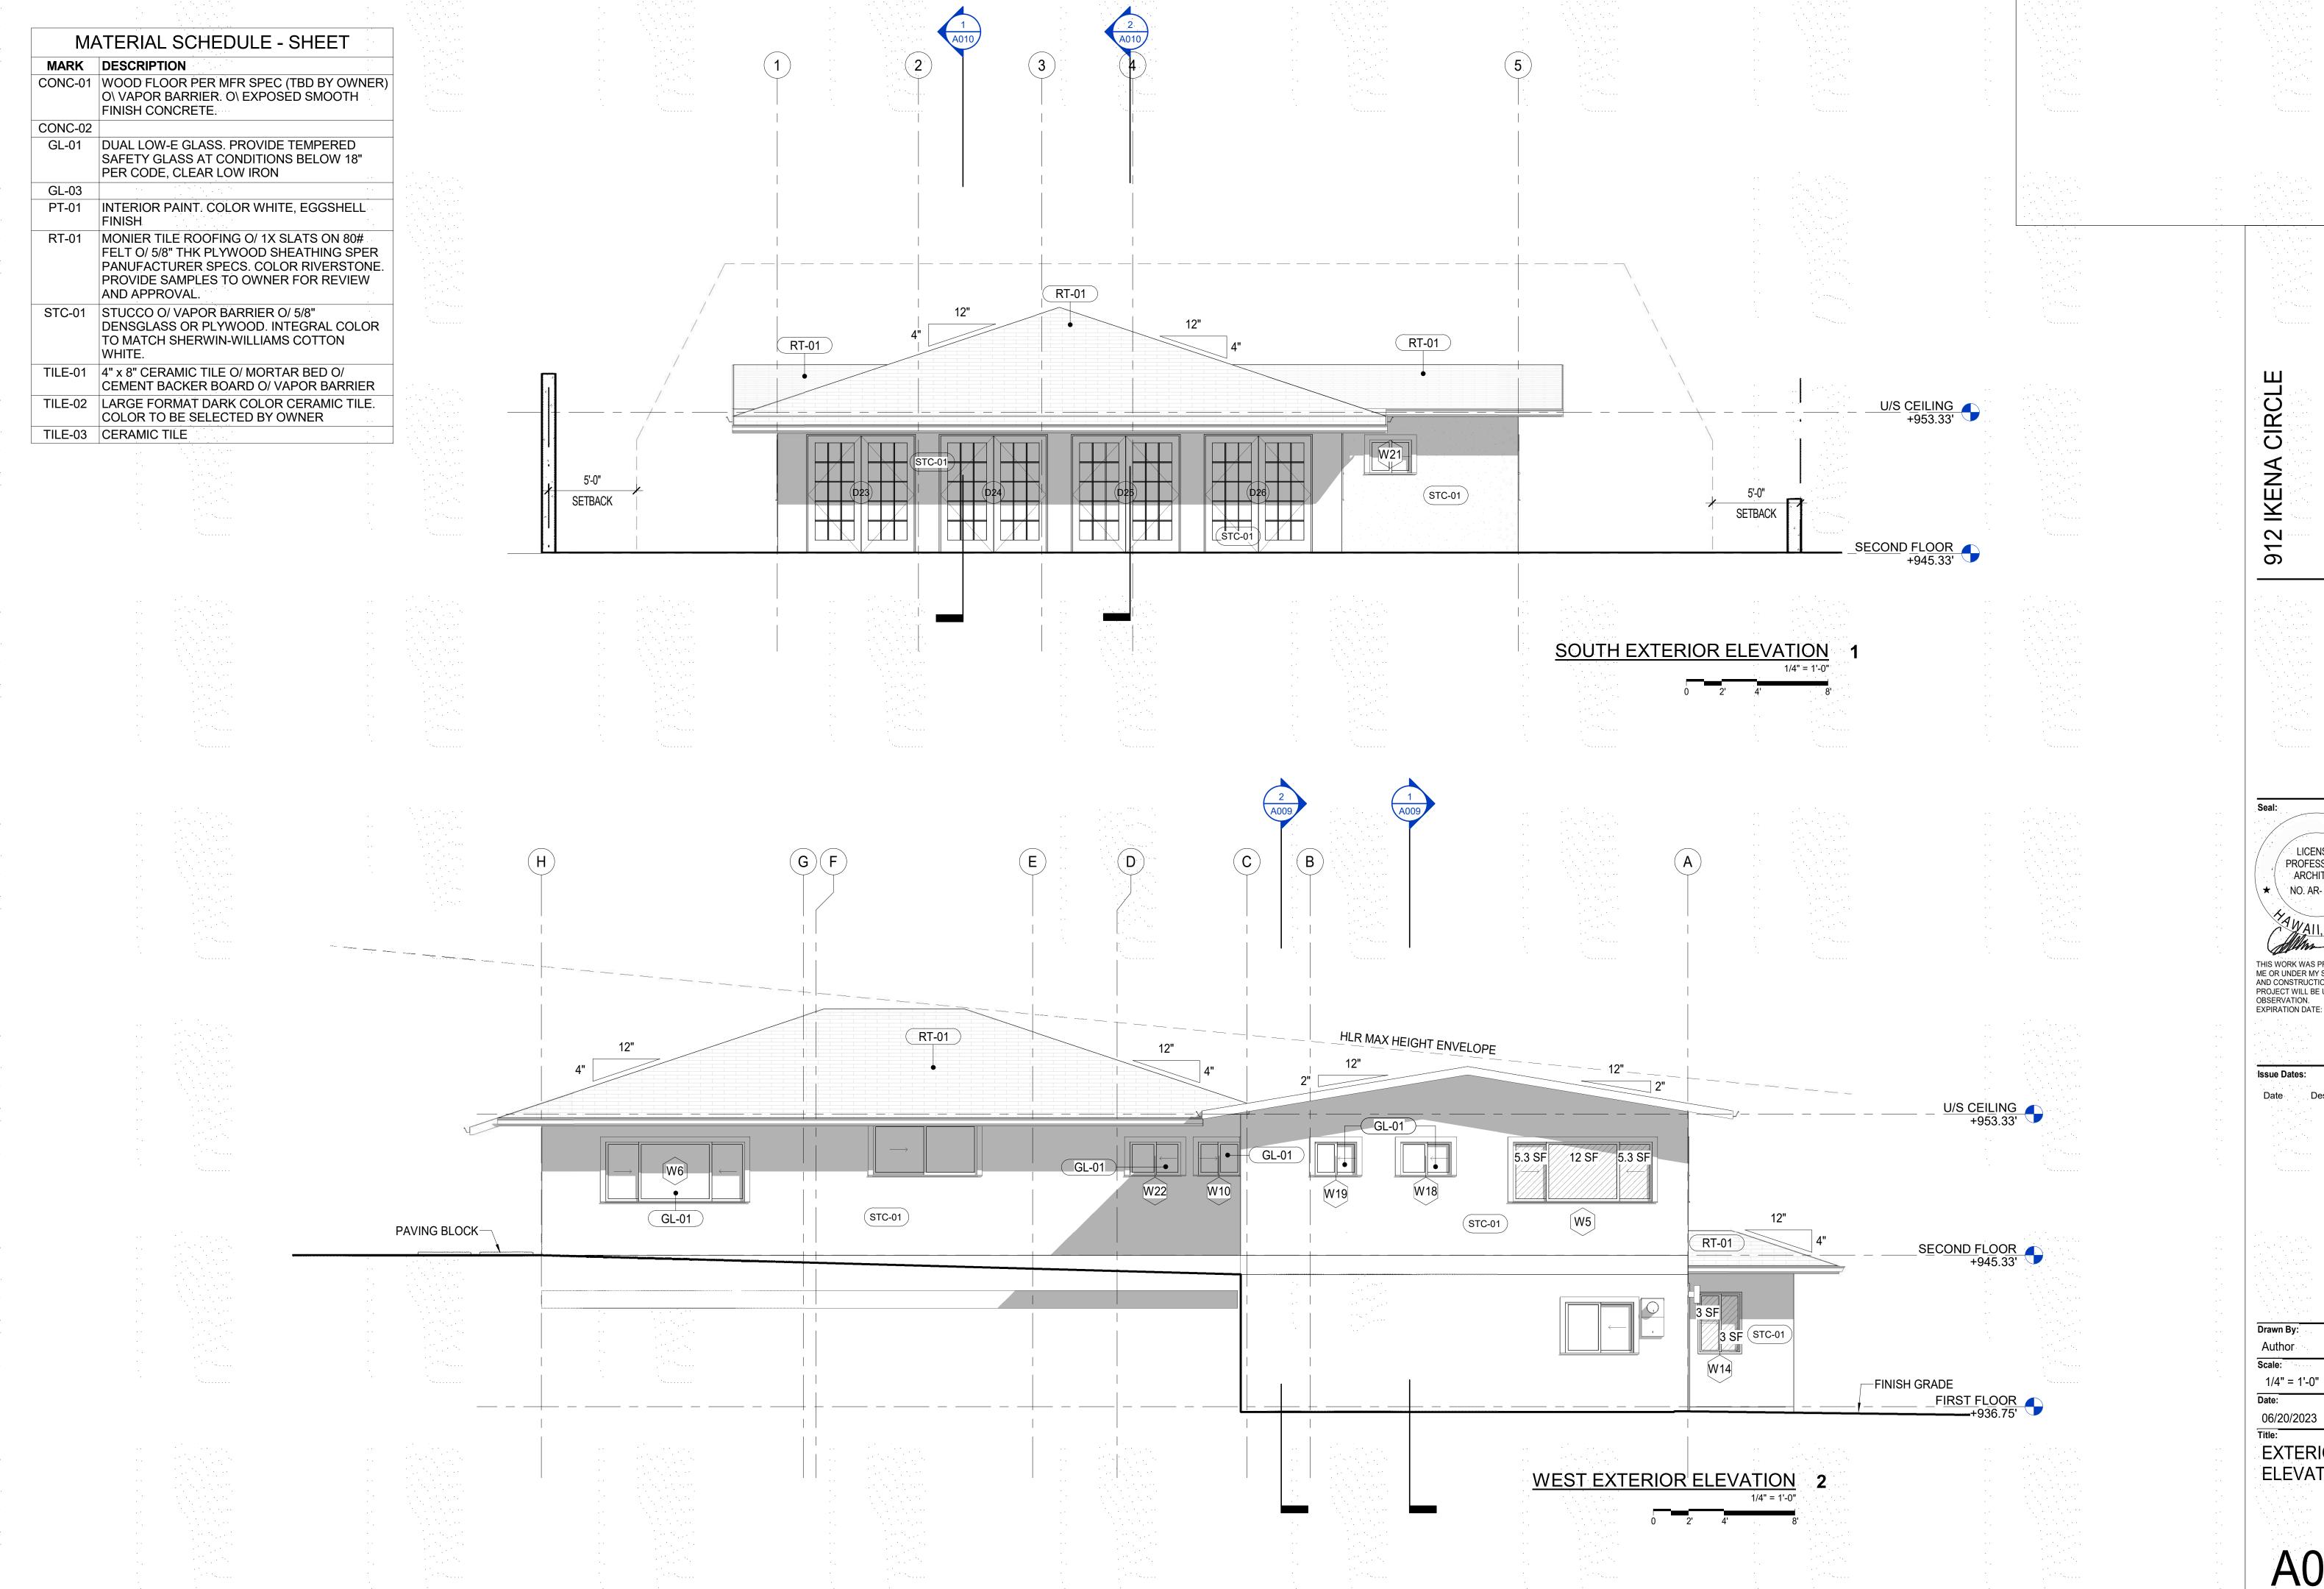

912 IKENA CIR, I **TMK: 37020030**


LICENSED PROFESSIONAL ARCHITECT ★ \ NO. AR-THIS WORK WAS PREPARED BY ME OR UNDER MY SUPERVISION AND CONSTRUCTION OF THIS PROJECT WILL BE UNDER MY OBSERVATION. EXPIRATION DATE: 04/30/2024

Issue Dates: Date Description

Author

06/20/2023

EXTERIOR ELEVATIONS

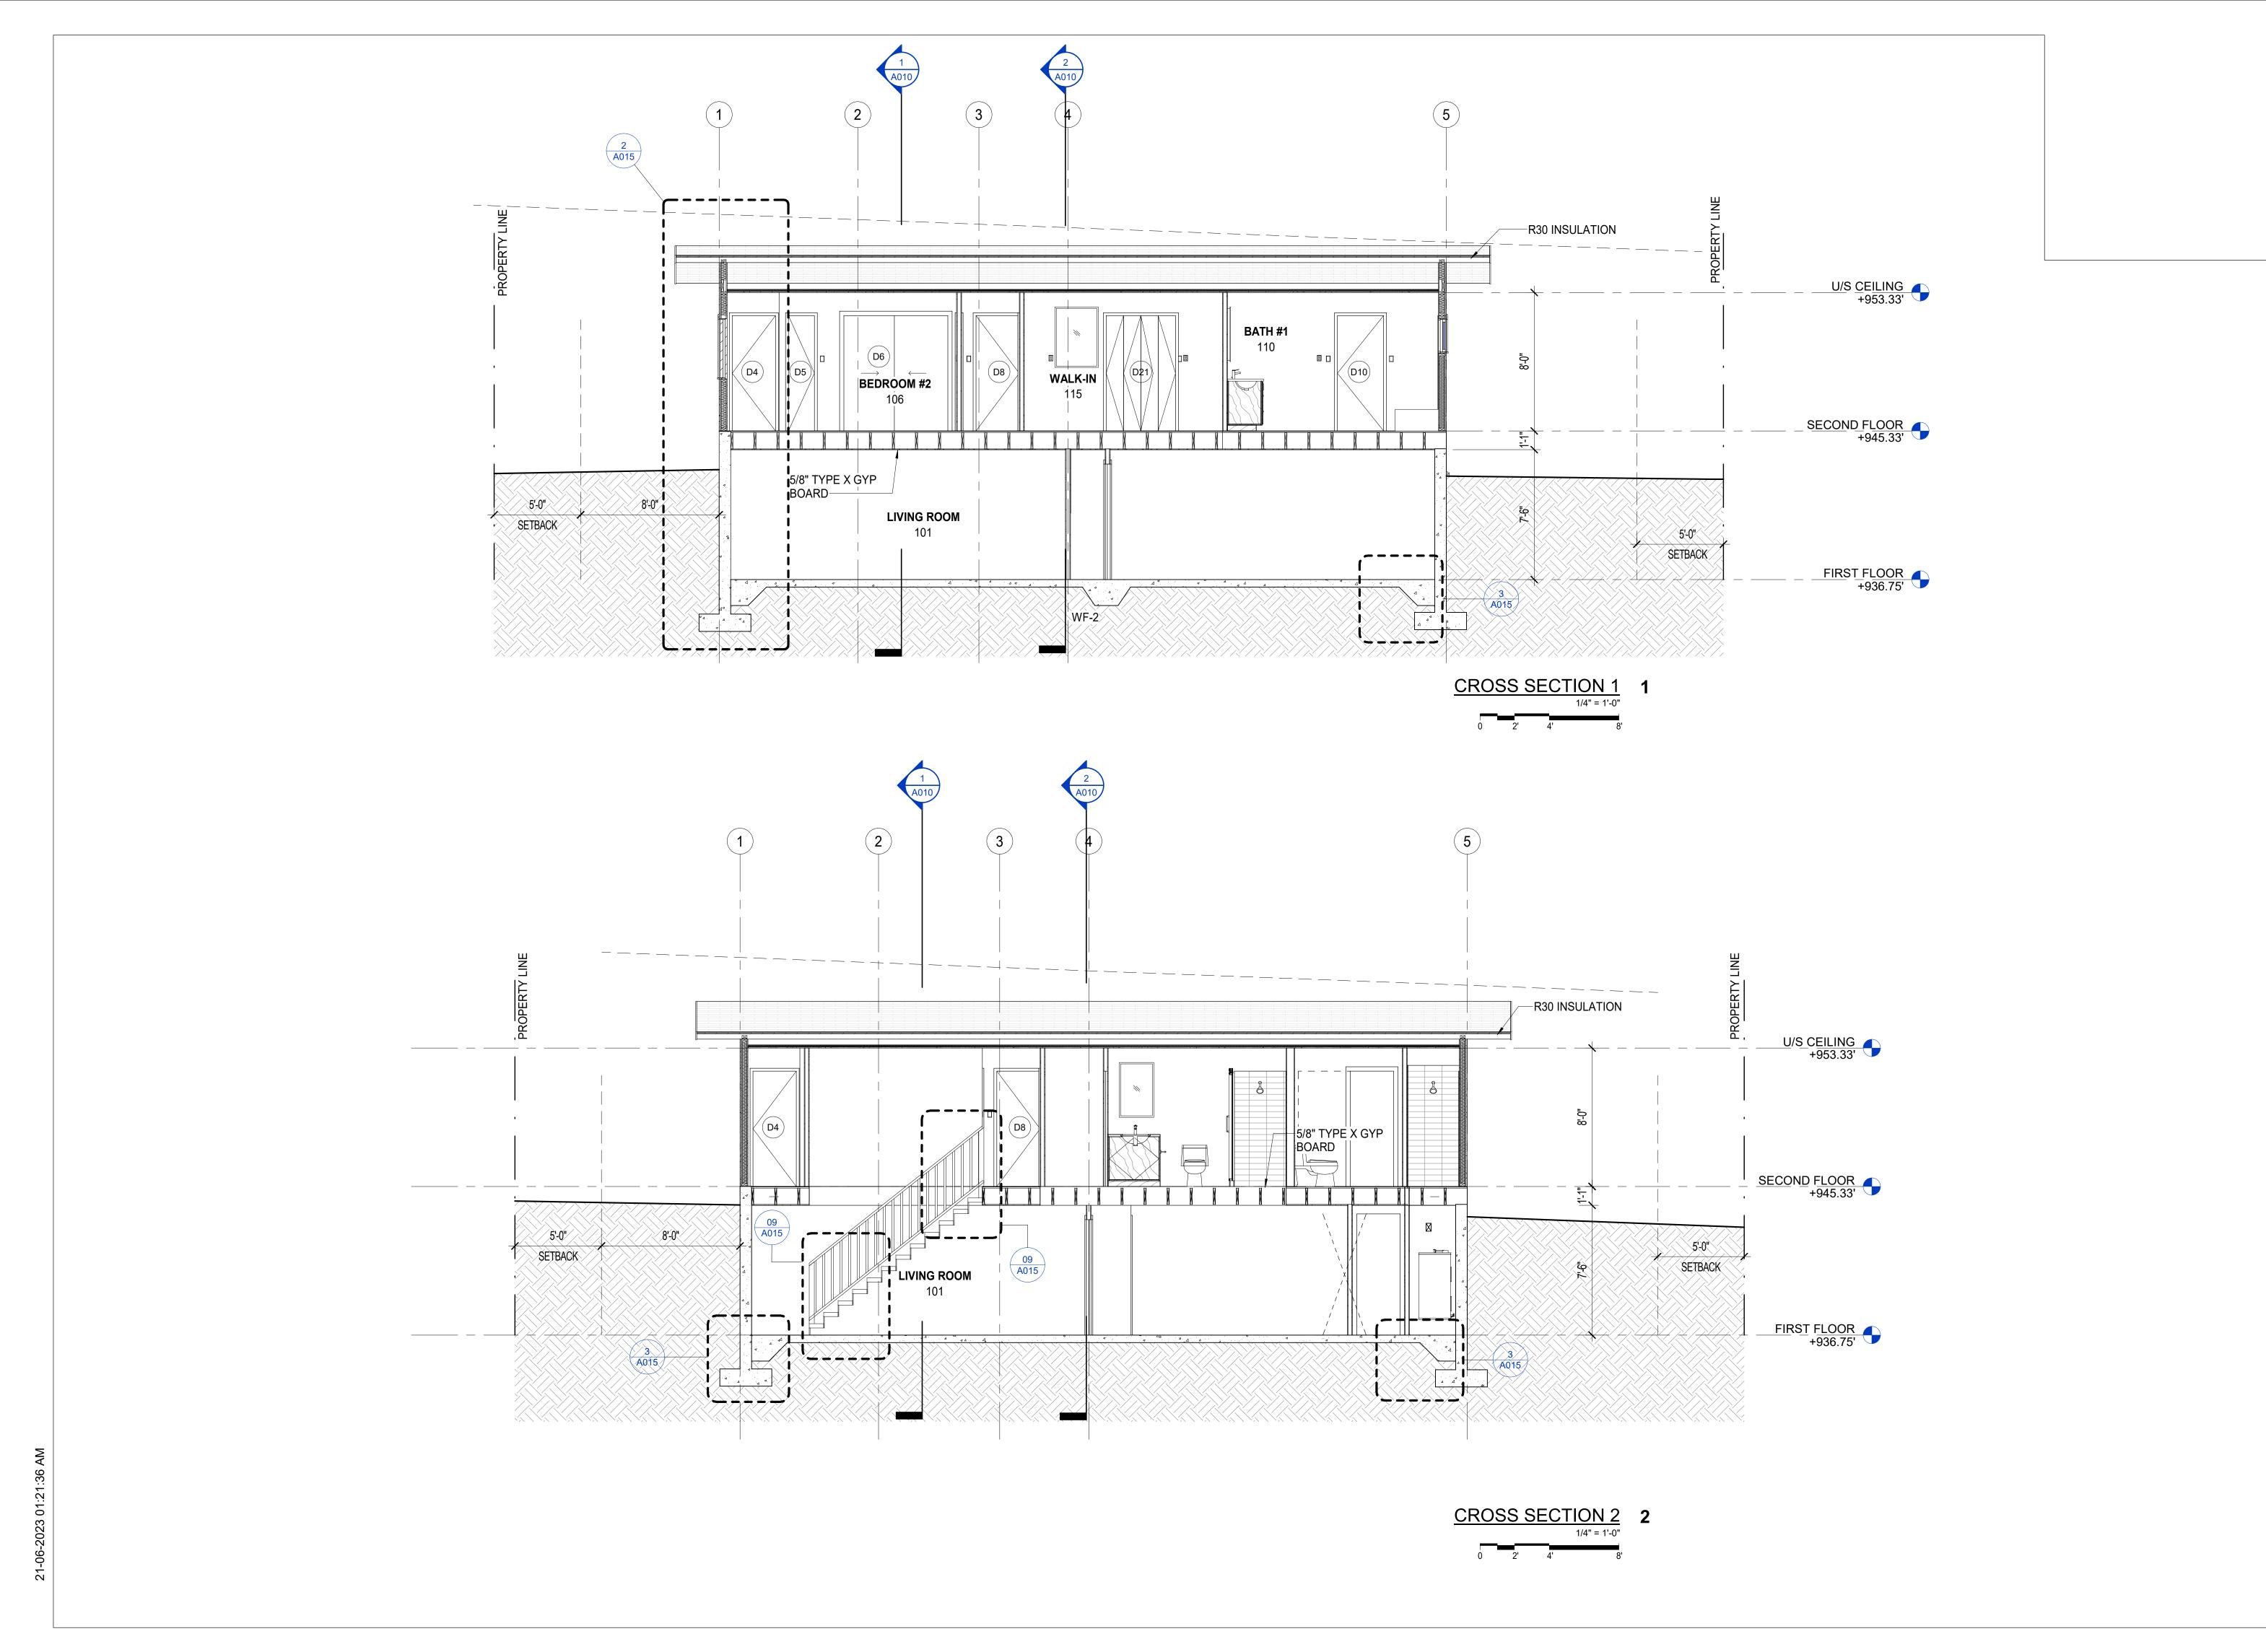

912 IKENA CIRCLE
912 IKENA CIR, HONOLULU, HI 96821
TMK: 37020030

LICENSED
PROFESSIONAL
ARCHITECT
NO. AR-'

THIS WORK WAS PREPARED BY
ME OR UNDER MY SUPERVISION
AND CONSTRUCTION OF THIS
PROJECT WILL BE UNDER MY
OBSERVATION.
EXPIRATION DATE: 04/30/2024

VATION.
TION DATE: 04/30/2024

Dates:

Issue Dates:

Date Description

Drawn By:


EA

Scale:

Scale: 1/4" = 1'-0" Date: 06/20/2023

Title:
BUILDING
SECTIONS

A009

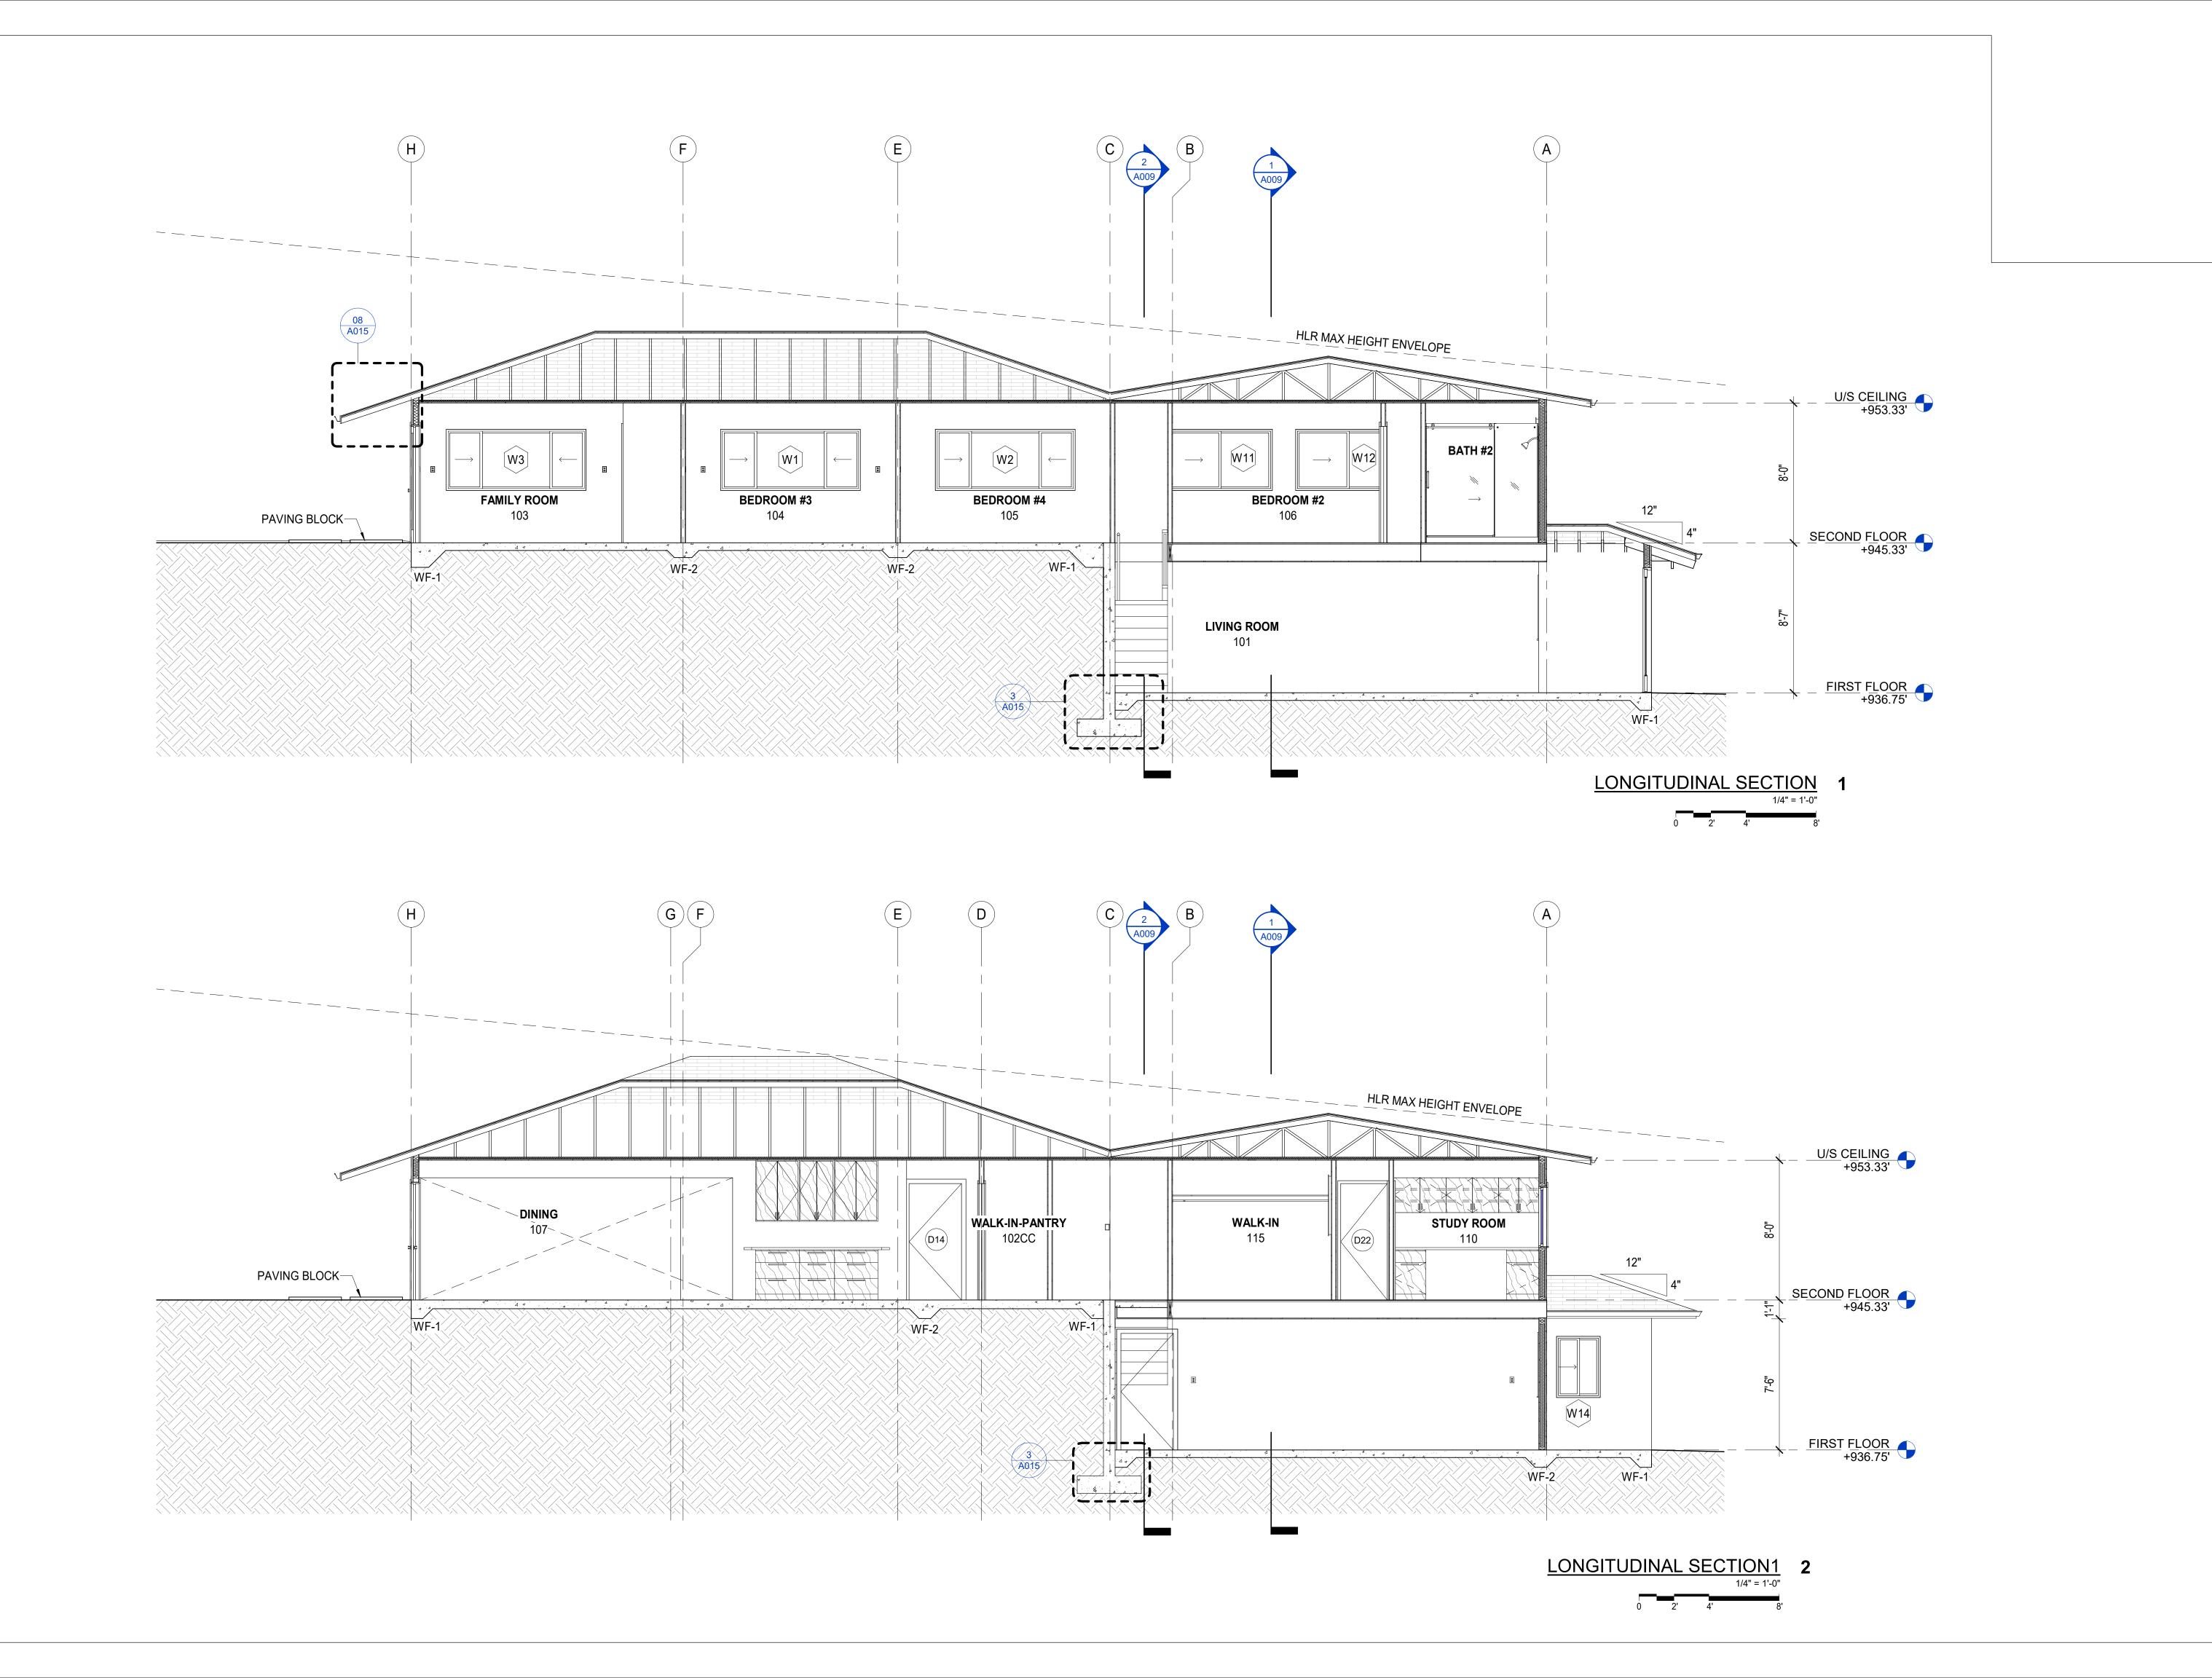

912 IKENA CIRCLE
912 IKENA CIR, HONOLULU, HI 96821
TMK: 37020030

LICENSED PROFESSIONAL ARCHITECT

THIS WORK WAS PREPARED BY ME OR UNDER MY SUPERVISION AND CONSTRUCTION OF THIS PROJECT WILL BE UNDER MY OBSERVATION. EXPIRATION DATE: 04/30/2024

Date Description

\★\ NO. AR-

Issue Dates:

Drawn By:
Author
Scale:
1/4" = 1'-0"

Date: 06/20/2023
Title:

BUILDING SECTIONS


A010

GENERAL NOTES:

ALL WINDOW FRAMES TO BE DARK BRONZE. PROVIDE MFR SAMPLE TO OWNER FOR REVIEW AND APPROVAL.


EGRESS NOTES:

- 1. 20" CLR MIN WIDTH
- 2. 24" CLR MIN HEIGHT 3. 57 SF MIN. OPENING AREA
- 4. 44" MAX FROM BOTTOM OF WINDOW OPENING TO FIN. FLOOR

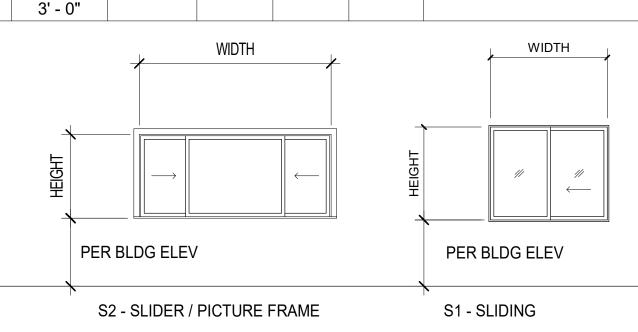

WINDOW TYPE LEGEND

DOOR SCHEDULE											
wtwte	TYPE	GLASS TYPE CONSTRUCTION TYPE	N FINISH	OPERATIO N	THICKNESS	WIDTH	HEIGHT	SILL HEIGHT	ROUGH WIDTH	ROUGH HEIGHT	COMMENTS
D3	В	IG Low E II with Argon			0' - 1 3/4"	6' - 0 5/8"	7' - 2"	0' - 0"	6' - 1 5/8"	7' - 2 1/2"	
D4	Α	HCWD			0' - 1 1/2"	2' - 6"	6' - 8"	0' - 0"	2' - 8"	6' - 9"	
D5	Α				0' - 1 1/2"	1' - 6"	6' - 8"	0' - 0"			
D6	F				0' - 2"	6' - 0"	6' - 8"	0' - 0"			
D7	Α	HCWD			0' - 1 1/2"	2' - 8"	6' - 8"	0' - 0"	2' - 10"	6' - 9"	
D8	Α				0' - 1 1/2"	2' - 6"	6' - 8"	0' - 0"			
D9	Α	HCWD			0' - 1 1/2"	2' - 8"	6' - 8"	0' - 0"	2' - 10"	6' - 9"	
D10	Α	HCWD			0' - 1 1/2"	2' - 8"	6' - 8"	0' - 0"	2' - 10"	6' - 9"	
D11	С				0' - 1 1/2"	2' - 6"	6' - 8"	0' - 0"			
D12	С				0' - 1 1/2"	2' - 6"	6' - 8"	0' - 0"			
D13	Α	HCWD			0' - 1 1/2"	3' - 0"	6' - 8"	0' - 0"	3' - 2"	6' - 9"	
D14	Α	HCWD			0' - 1 1/2"	3' - 0"	6' - 8"	0' - 0"	3' - 2"	6' - 9"	
D15	D	HCWD			0' - 2"	5' - 8"	6' - 8"	0' - 0"			
D16	D	HCWD			0' - 2"	5' - 8"	6' - 8"	0' - 0"			
D17	Α	HCWD			0' - 1 1/2"	2' - 6"	6' - 8"	0' - 0"	2' - 8"	6' - 9"	
D21	E				0' - 1 1/2"	4' - 0"	6' - 8"	0' - 0"			
D22	Α	HCWD			0' - 1 1/2"	2' - 8"	6' - 8"	0' - 0"	2' - 10"	6' - 9"	
D23	G				0' - 1 1/2"	6' - 0"	6' - 8"	0' - 0"	6' - 1 31/32"	6' - 8 63/64"	
D24	G				0' - 1 1/2"	6' - 0"	6' - 8"	0' - 0"	6' - 1 31/32"	6' - 8 63/64"	
D25	G				0' - 1 1/2"	6' - 0"	6' - 8"	0' - 0"	6' - 1 31/32"	6' - 8 63/64"	
D26	G				0' - 1 1/2"	6' - 0"	6' - 8"	0' - 0"	6' - 1 31/32"	6' - 8 63/64"	
D28	Α	HCWD			0' - 1 1/2"	2' - 6"	6' - 8"	0' - 0"	2' - 8"	6' - 9"	
D29	Е				0' - 1 1/2"	3' - 0"	6' - 8"	0' - 0"			
D30	0					16' - 0"	7' - 0"	-0' - 3"			
D31	F				0' - 2"	6' - 0"	6' - 8"	0' - 0"			
D32	F				0' - 2"	6' - 0"	6' - 8"	0' - 0"			
D33	Α	HCWD			0' - 1 1/2"	3' - 0"	6' - 8"	0' - 0"	3' - 2"	6' - 9"	
D24	Г				01 011	CI OII	CI OII	01 011			

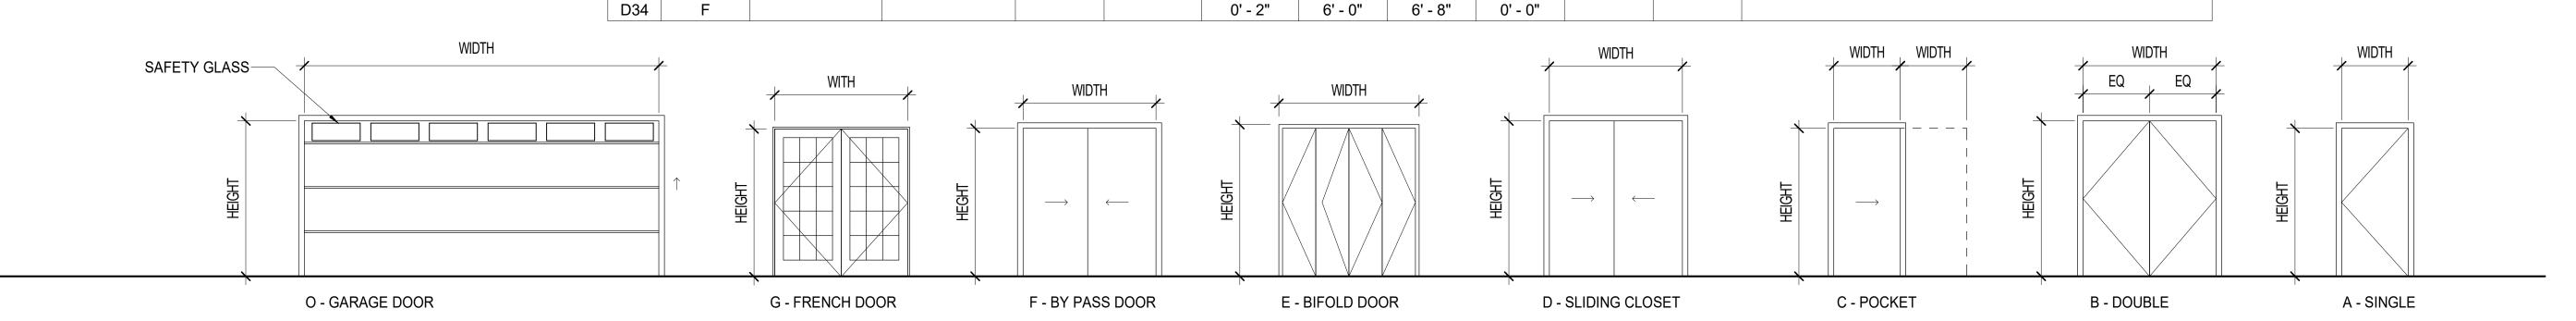

DOOR TYPE LEGEND

9682 王 CIRCLI 912 IKENA CIR, I **TMK: 37020030** IKENA 912

MATERIAL SCHEDULE

CONC-01 WOOD FLOOR PER MFR SPEC (TBD BY OWNER) O\

GL-01 DUAL LOW-E GLASS. PROVIDE TEMPERED SAFETY

PT-01 INTERIOR PAINT. COLOR WHITE, EGGSHELL FINISH

RT-01 MONIER TILE ROOFING O/ 1X SLATS ON 80# FELT O/

STC-01 STUCCO O/ VAPOR BARRIER O/ 5/8" DENSGLASS OR PLYWOOD. INTEGRAL COLOR TO MATCH

PANUFACTURER SPECS. COLOR RIVERSTONE.

PROVIDE SAMPLES TO OWNER FOR REVIEW AND

5/8" THK PLYWOOD SHEATHING SPER

SHERWIN-WILLIAMS COTTON WHITE.

BACKER BOARD O/ VAPOR BARRIER

TO BE SELECTED BY OWNER

TILE-01 4" x 8" CERAMIC TILE O/ MORTAR BED O/ CEMENT

TILE-02 LARGE FORMAT DARK COLOR CERAMIC TILE. COLOR

VAPOR BARRIER. O\ EXPOSED SMOOTH FINISH

GLASS AT CONDITIONS BELOW 18" PER CODE,

MARK DESCRIPTION

CONC-02

CONCRETE.

APPROVAL.

TILE-03 | CERAMIC TILE

CLEAR LOW IRON

LICENSED PROFESSIONAL ARCHITECT ★ 🔪 NO. AR 🗎 THIS WORK WAS PREPARED BY ME OR UNDER MY SUPERVISION AND CONSTRUCTION OF THIS

PROJECT WILL BE UNDER MY OBSERVATION. EXPIRATION DATE: 04/30/2024

Issue Dates:


Date Description

Drawn By:


Author Scale: 1/4" = 1'-0"

06/20/2023

SCHEDULES

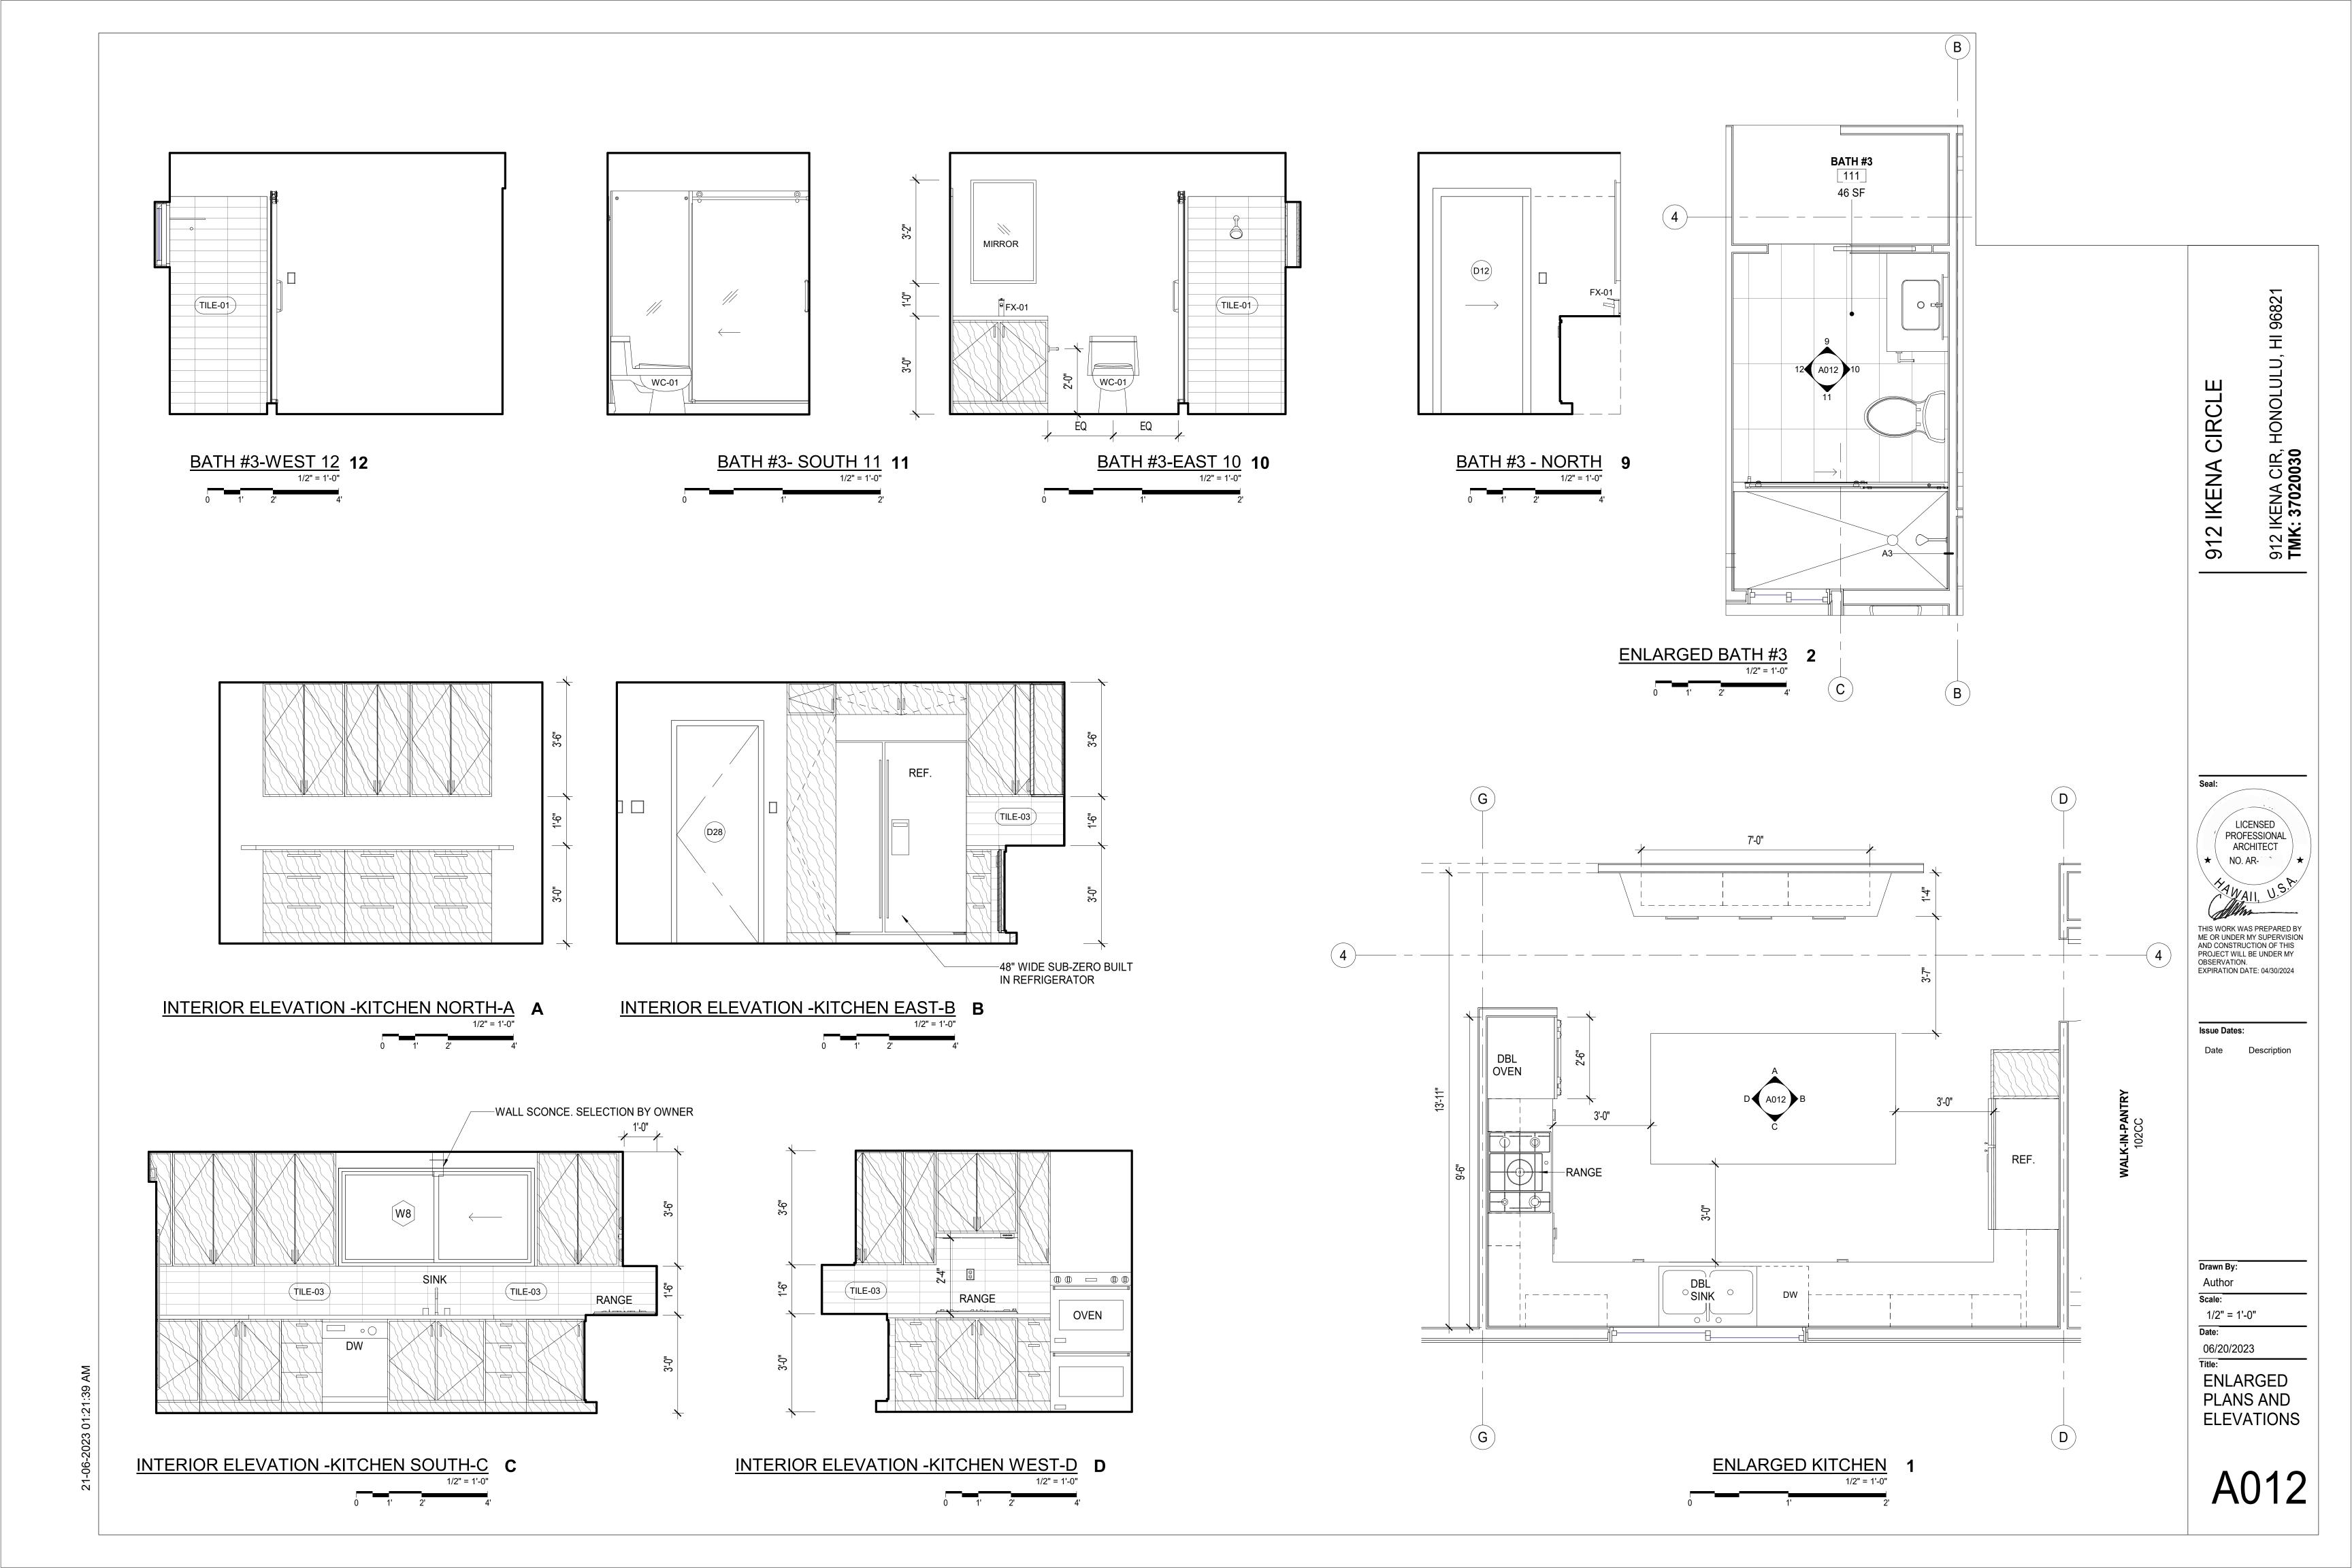



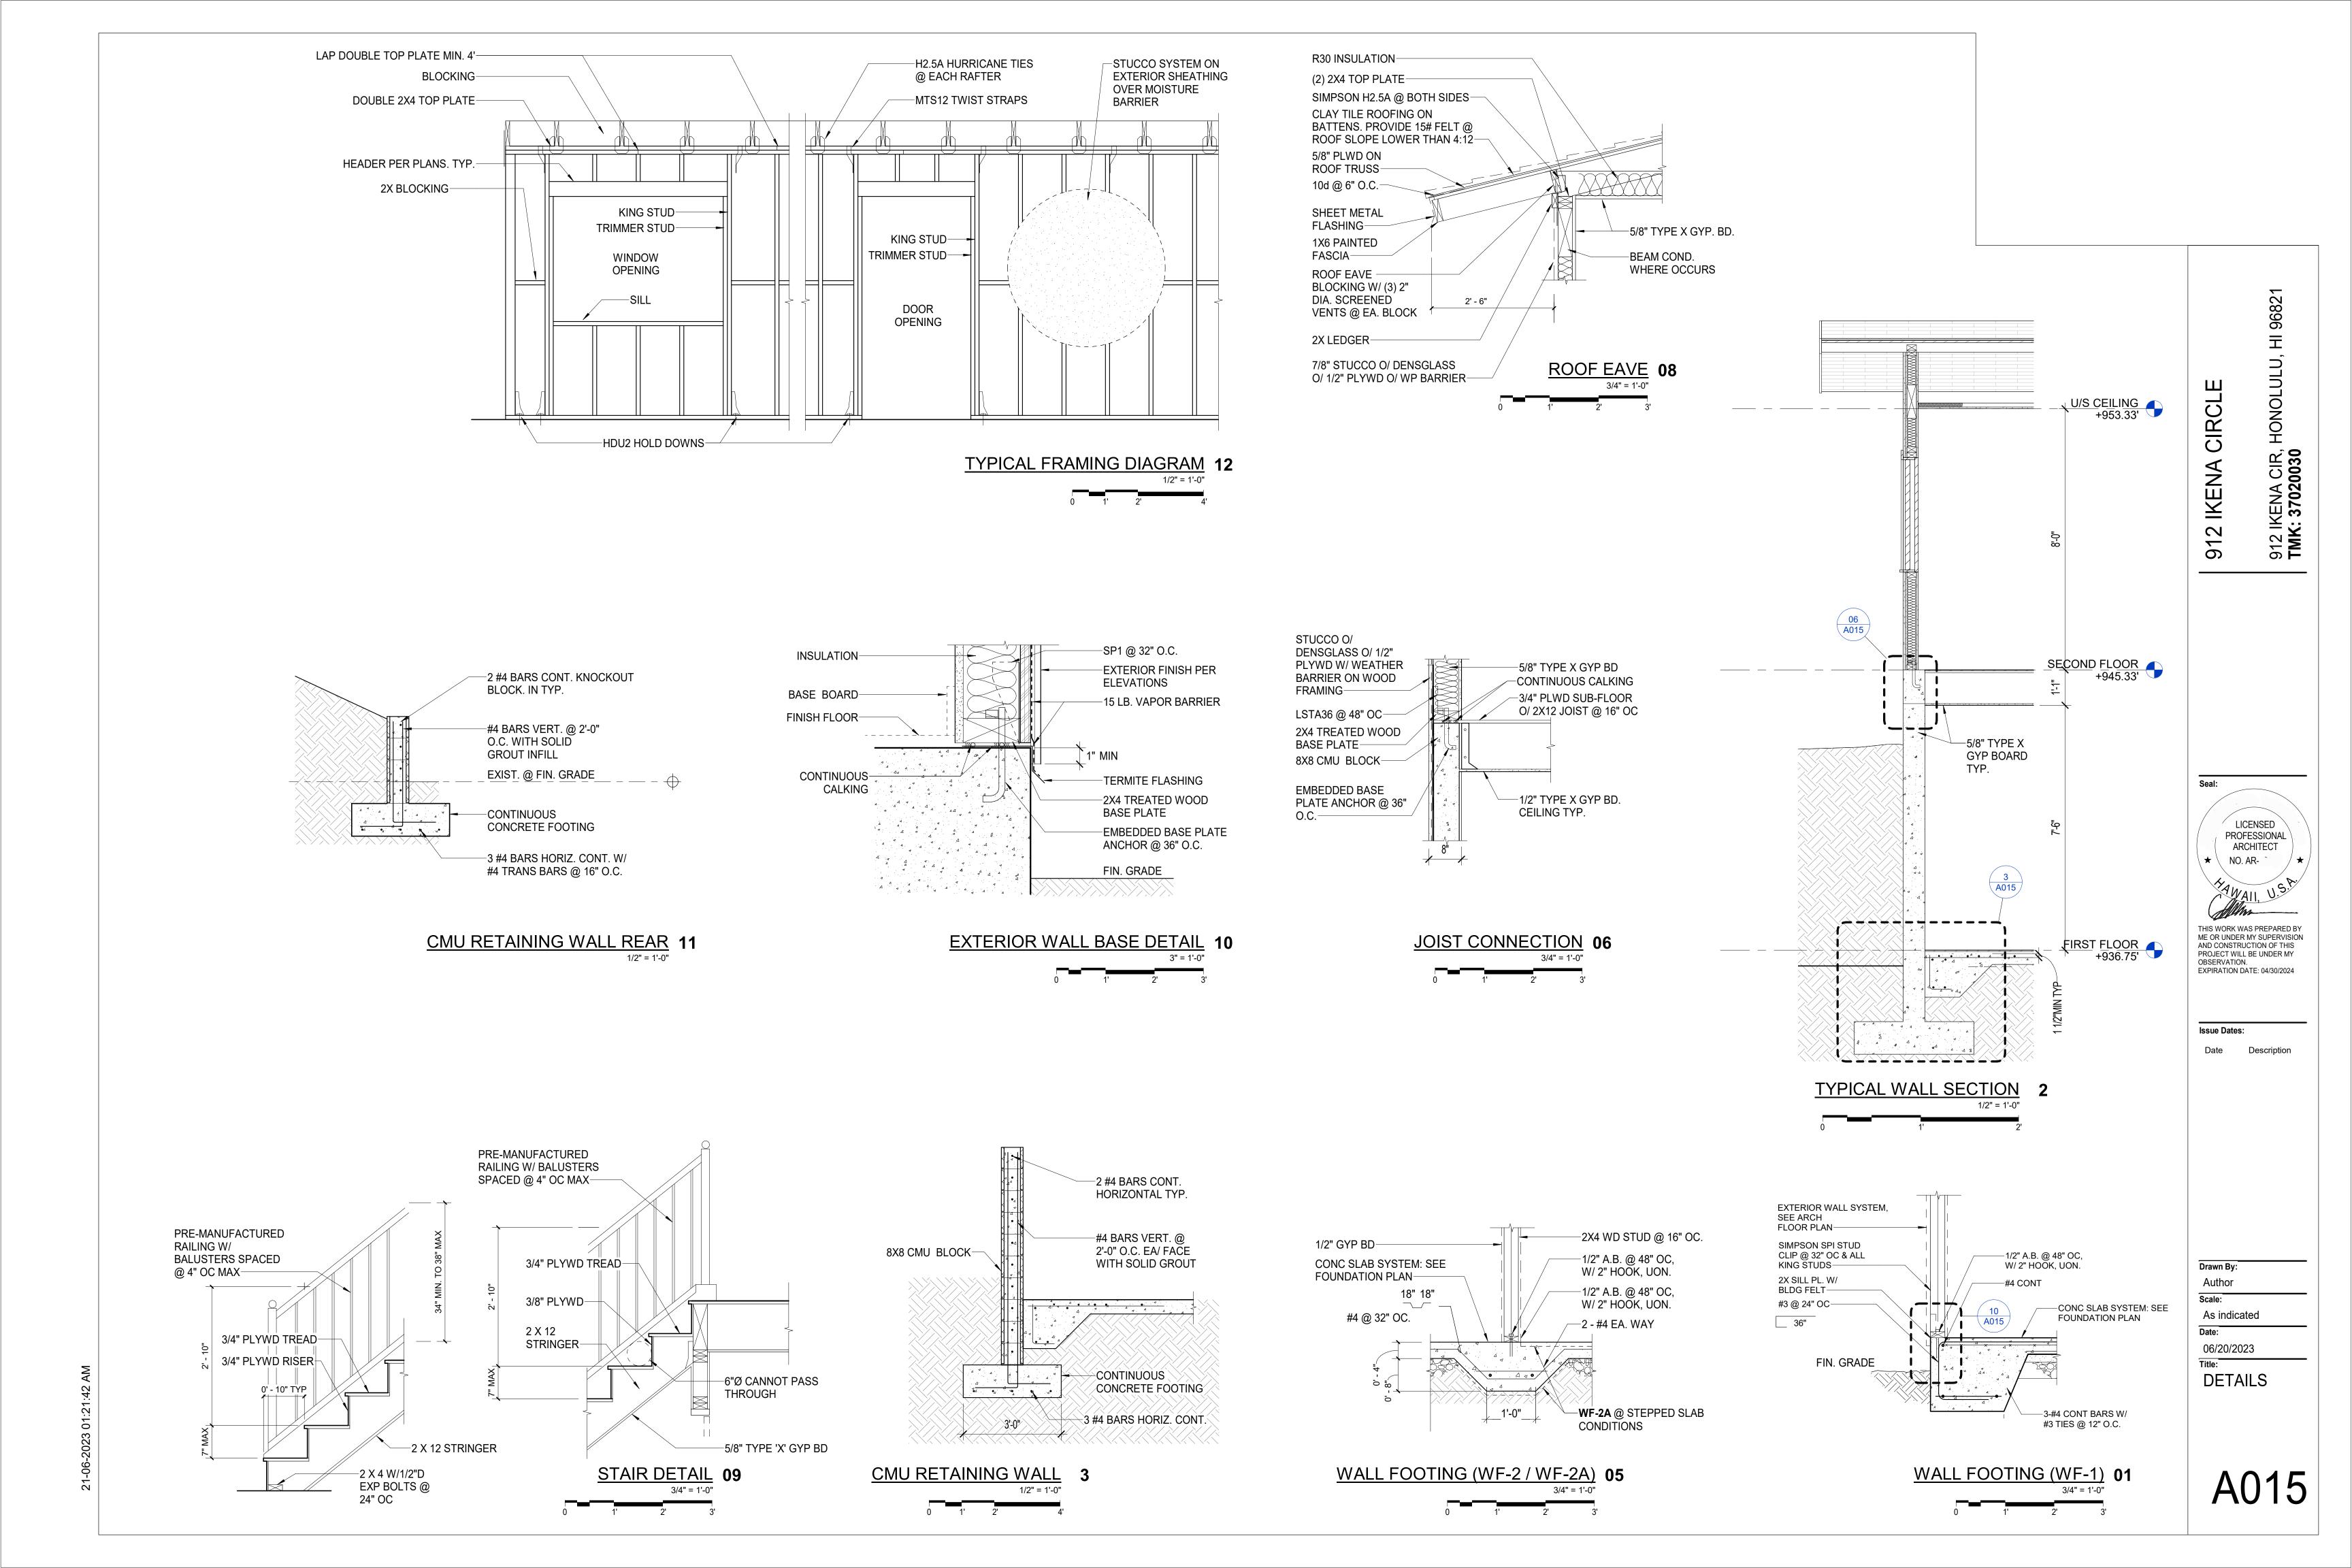

ELECTRICAL & LIGHTING SYMBOLS

- 4" RECESSED DIMMABLE LED CAN LIGHT
- → SURFACE MOUNTED CAN / WALL SCONCE
- INDICATES WATERPROOF

 EXTERIOR WALL SCONCE

SUSPEND

SUSPENDED LINEAR LIGHT FIXTURE

----- LINEAR LED UNDERCABINET LIGHT FIXTURE

EXHAUST FAN / VTR

▼ COAXIAL TV CABLE CONNECTION

U.L. APPROVED HARDWIRED SMOKE ALARM W/ BATTERY BACK-UP PER 2012 IRC SEC R314

> CARBON MONOXIDE ALARM PER 2012 IRC SEC R315

COMBINATION SMOKE / CARBON MONOXIDE ALARM W/ BATTERY BACK-UP PER 2012 IRC SEC R314 / R315

CEILING MOUNTED LIGHT FIXTURE

CEILING MOUNTED LIGHT WITH INTEGRATED FAN

CEILING JBOX FOR FAN / LIGHT. TBD BY OWNER.

DUPLEX RECEPTACLE 18" AFF U.O.N.

DOUBLE DUPLEX RECEPTACLE 18"

AFF U.O.N.

\$\Psi_{WP}\$ DUPLEX RECEPTACLE 18" AFF U.O.N. W/ WEATHERPROOF ENCLOSURE


\$\Pi_{220V}\$ 220 V RECEPTACLE 18" AFF U.O.N.

\$\Phi_{GFI}\$ 110 V GROUND FAULT CIRCUIT INTERRUPTER DUPLEX RECEPTACLE

SINGLE POLE SWITCH

3-WAY SWITCH

DIMMER SWITCH

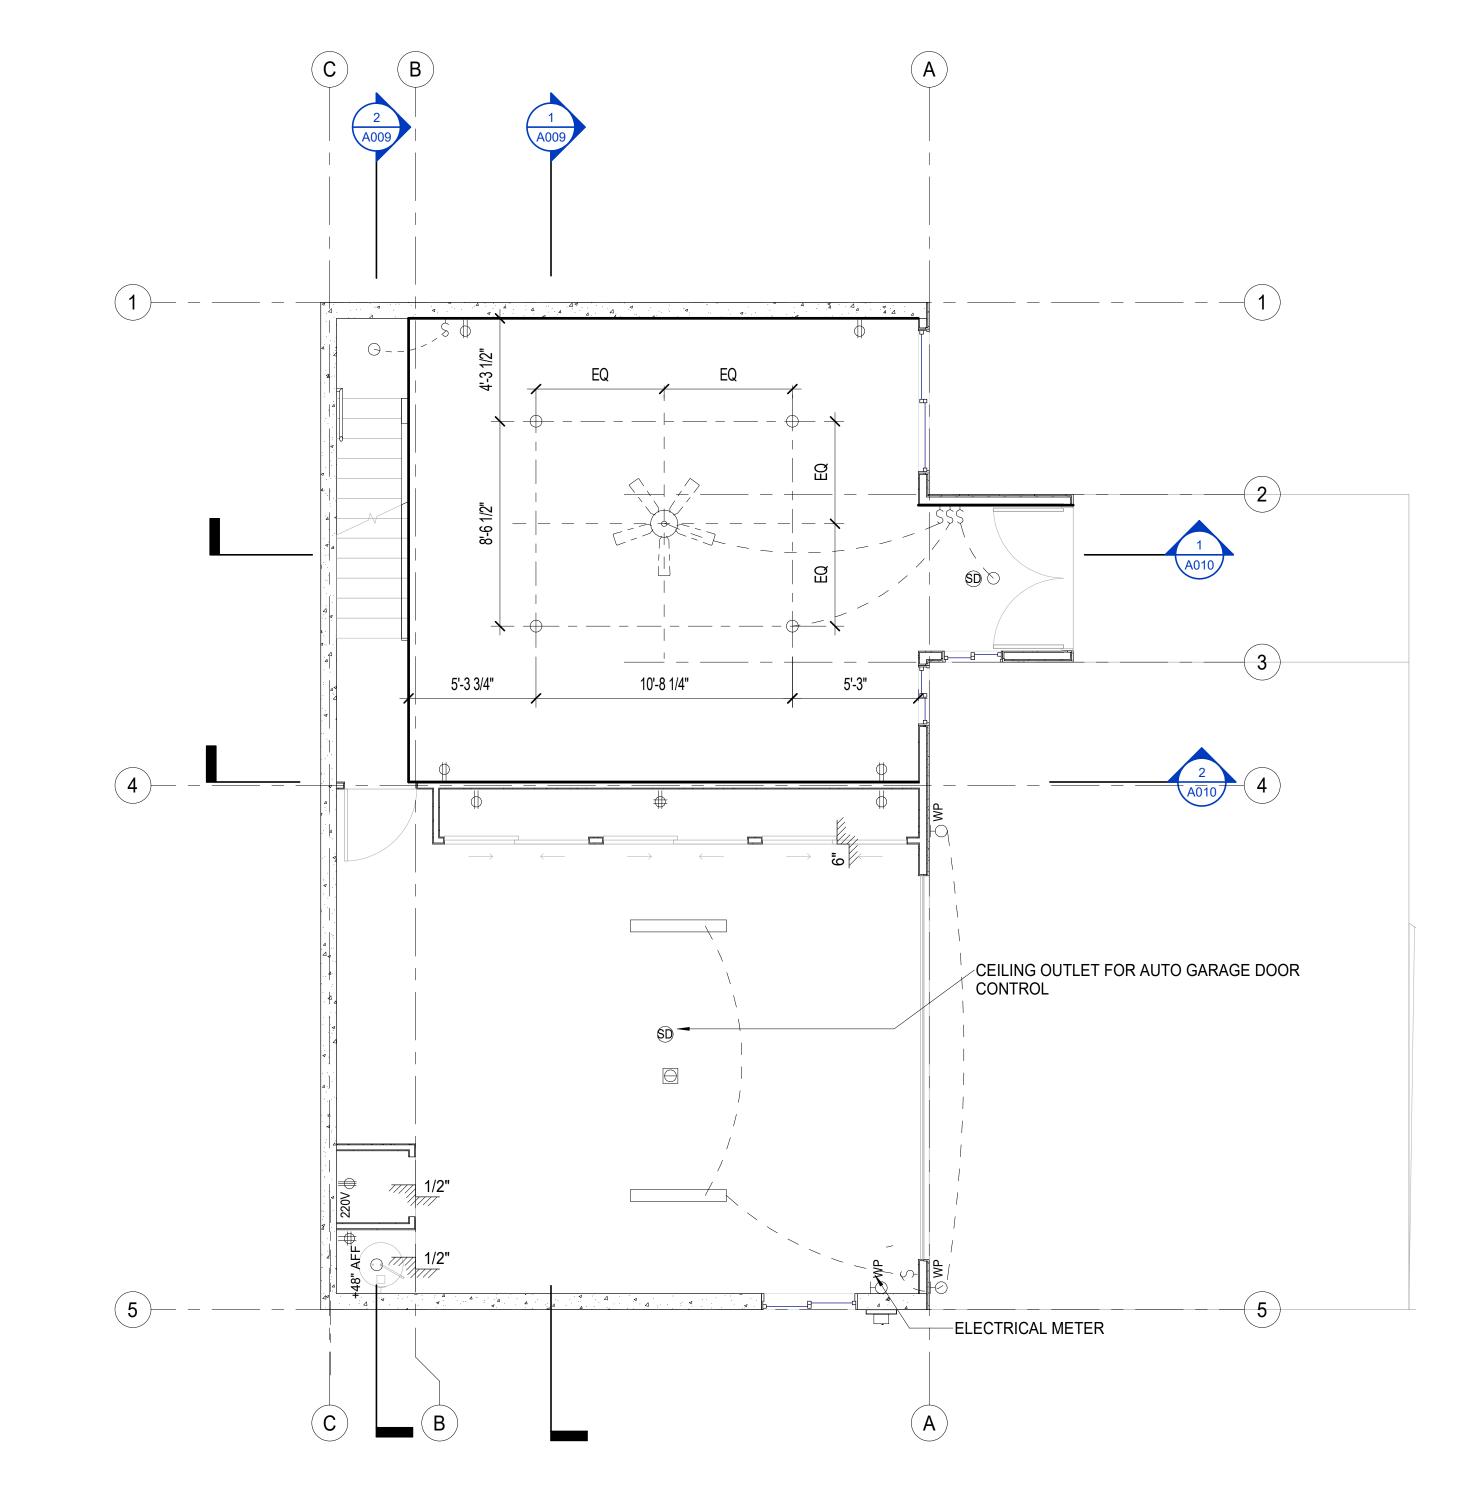

912 IKENA CIR, HONOLULU, HI 9682 **TMK: 37020030**

CIRCLE

912 IKENA


EXPIRATION DATE: 04/30/2024

1/4" = 1'-0"

Date:

06/20/2023 Title:

FIRST FLOOR ELECTRICAL PLAN

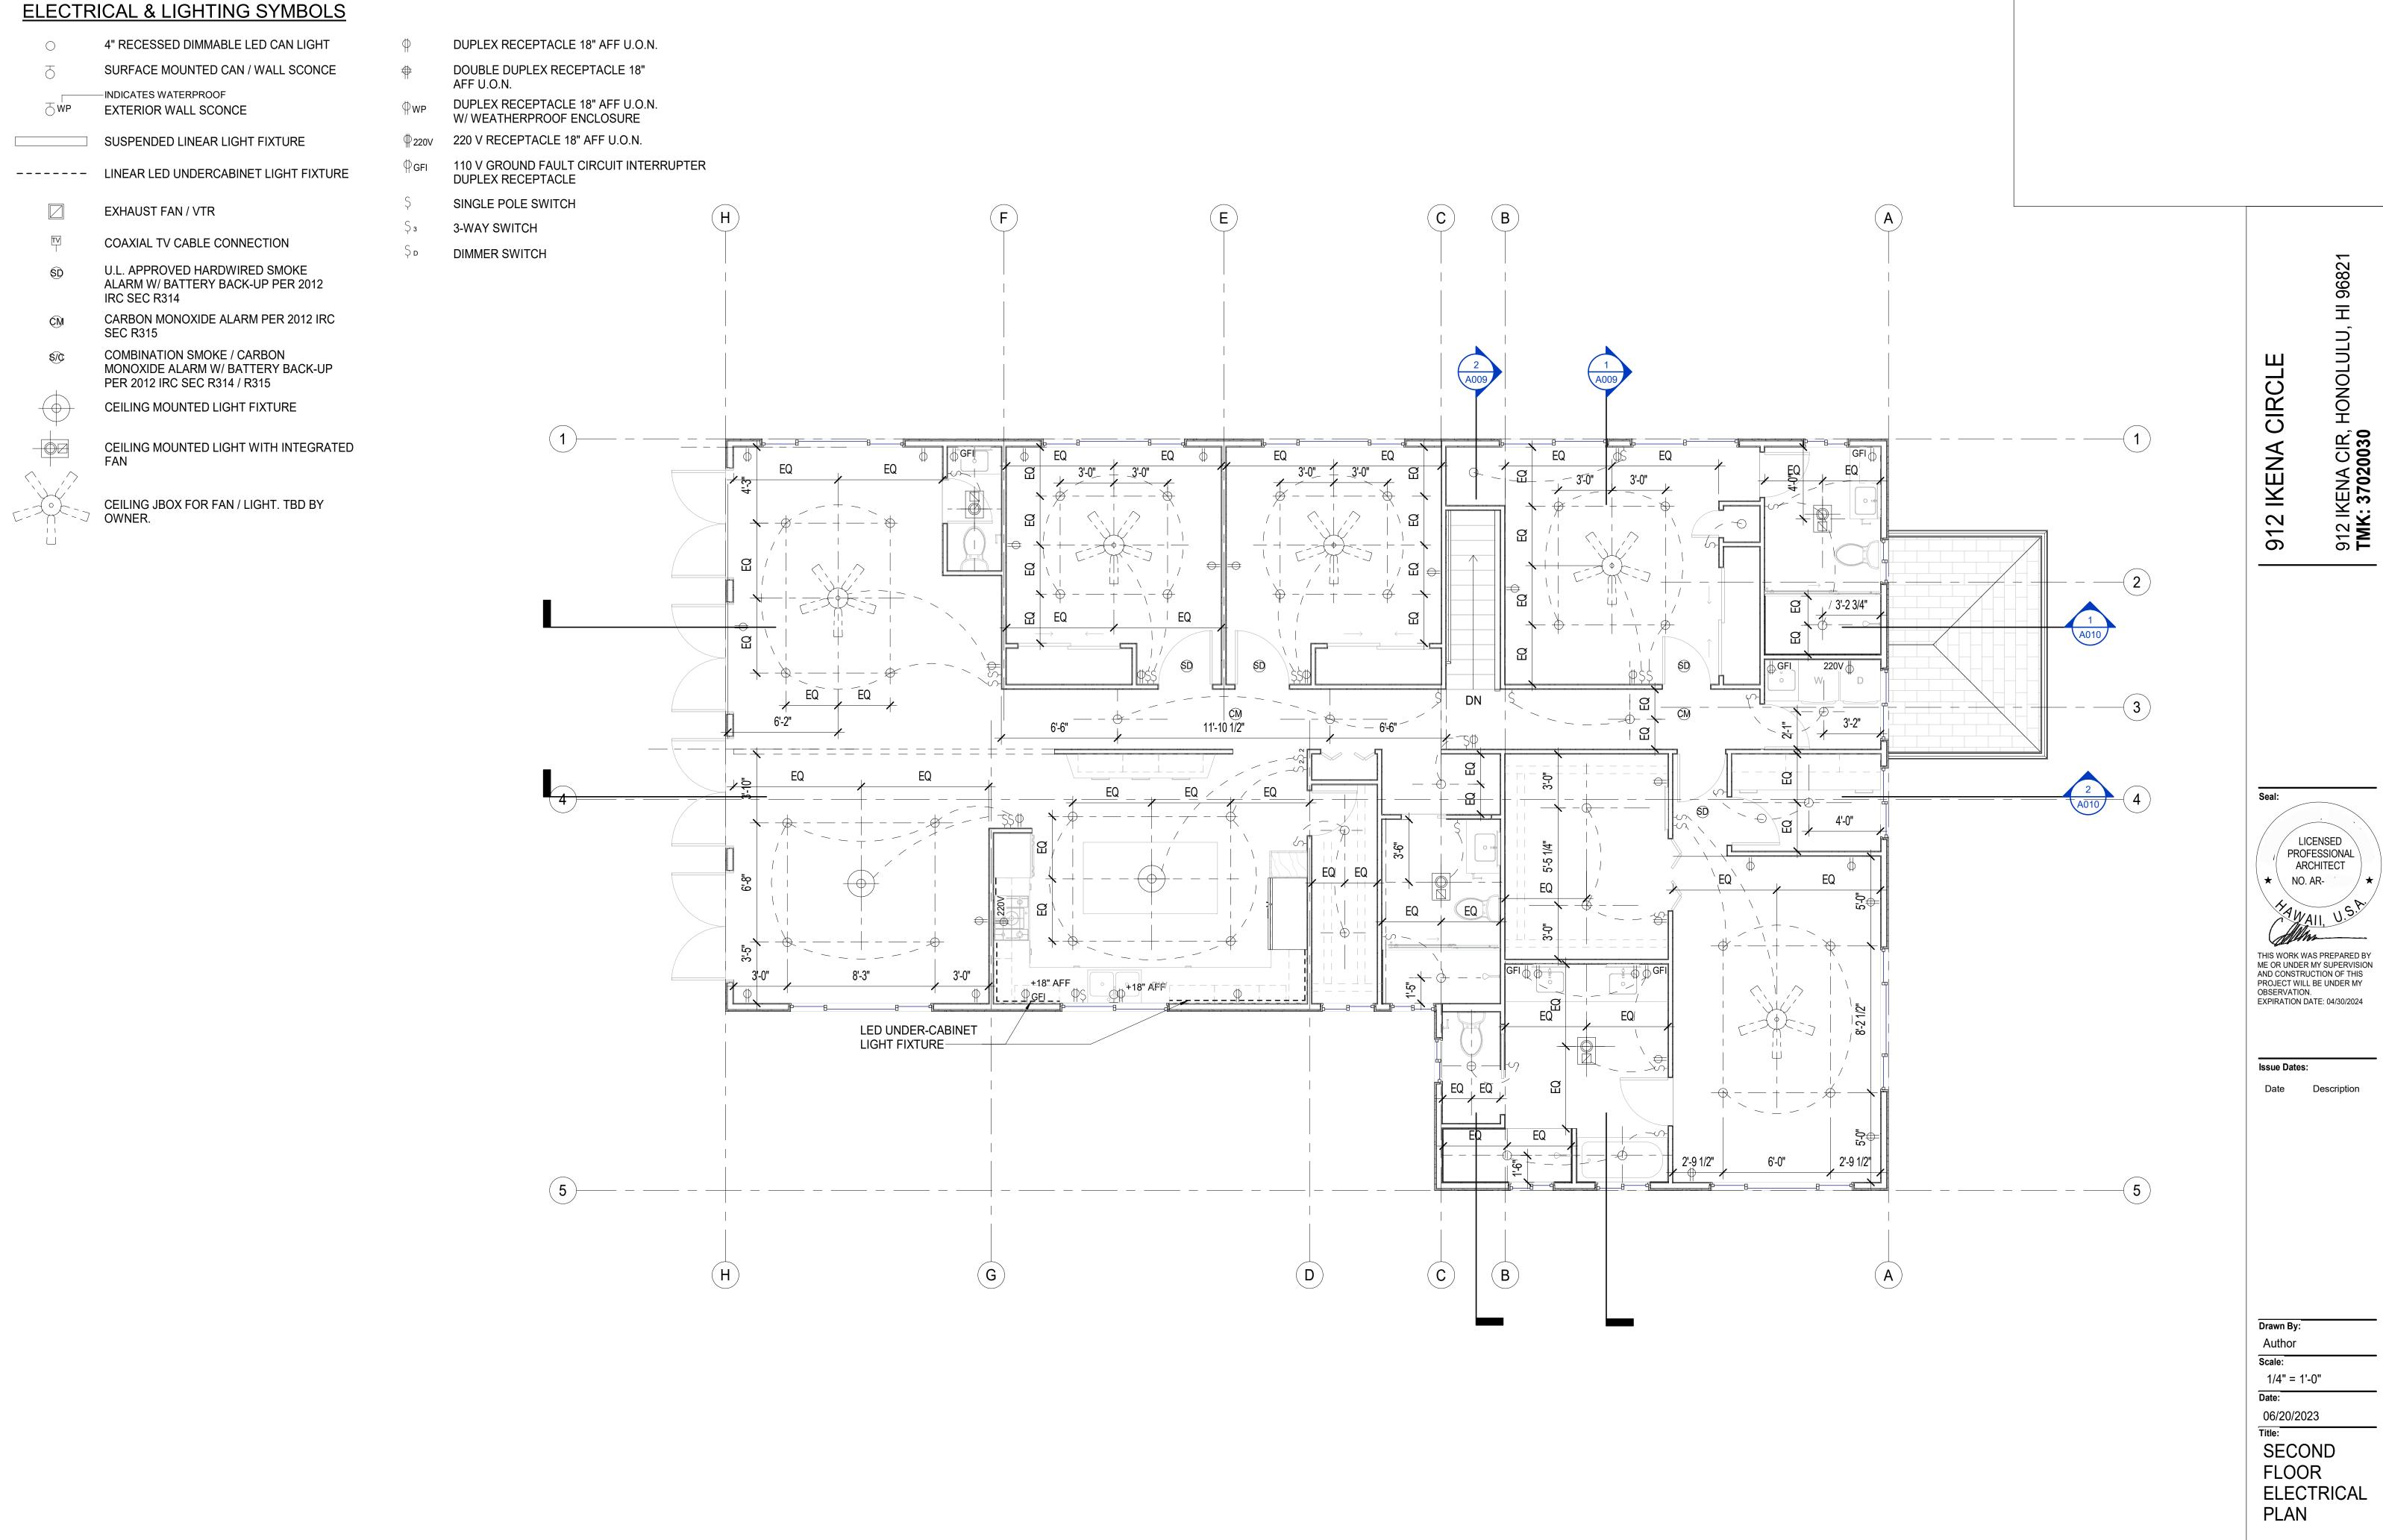

7.0000

ELECTRICAL & LIGHTING SECOND FLOOR PLAN

1/4" = 1'-0"

E002

GENERAL NOTES

- A. WORKMANSHIP AND MATERIALS SHALL CONFORM TO 2012 BUILDING CODE. WHERE REFERENCE F. IS MADE TO PERFORM CONFORMANCE TO OTHER STANDARDS, MORE STRINGENT REQUIREMENT
- B. NOTIFY STRUCTURAL HAWAII, INC. (SHI) AT 488-5000 OF ANY DEVIATIONS OR DISCREPANCIES FROM THESE PLANS DUE TO UNFORESEEN OR VARYING FIELD CONDITIONS INCLUDING DOCUMENTS WITH EACH OTHER. CONTRACTOR SHALL TAKE FIELD MEASUREMENTS AND VERIFY CONDITIONS AND SHALL COMPARE SUCH FIELD MEASUREMENTS AND CONDITIONS WITH DRAWINGS BEFORE COMMENCING WORK. REPORT IN WRITING TO DESIGN PROFESSIONAL OF RECORD ALL INCONSISTENCIES AND OMISSIONS.
- C. NEITHER PROFESSIONAL ACTIVITIES OF STRUCTURAL HAWAII, INC. (SHI), NOR PRESENCE OF SHI OR SHI'S EMPLOYEES AT CONSTRUCTION SITE, SHALL RELIEVE GENERAL CONTRACTOR AND ANY OTHER ENTITY OF THEIR OBLIGATIONS, DUTIES, AND RESPONSIBILITIES INCLUDING, BUT NOT LIMITED TO, CONSTRUCTION MEANS, METHODS, SEQUENCES, TECHNIQUES, OR PROCEDURES NECESSARY FOR PERFORMING, SUPERINTENDING, OR COORDINATING ALL PORTIONS OF WORK OF ALL TRADES OF CONSTRUCTION IN ACCORDANCE WITH CONTRACT DOCUMENTS AND ANY HEALTH OR SAFETY PRECAUTIONS REQUIRED BY ANY REGULATORY AGENCIES. SHI AND SHI'S PERSONNEL HAVE NO AUTHORITY TO EXERCISE ANY CONTROL OVER ANY CONSTRUCTION CONTRACTOR OR OTHER ENTITY OR THEIR EMPLOYEES IN CONNECTION WITH THEIR WORK OR ANY HEALTH OR SAFETY PRECAUTIONS.
- D. ALL WORK DAMAGED IN PERFORMANCE OF NEW WORK SHALL BE REPAIRED. PATCH ALL DAMAGE TO EXISTING SURFACES RESULTING FROM THIS WORK. FINISH TO MATCH EXISTING REINFORCING STEEL
- E. CONSTRUCTION LOADING SHALL NOT EXCEED DESIGN LIVE LOAD UNLESS SPECIAL SHORING IS PROVIDED. ALLOWABLE LOADS SHALL BE REDUCED IN AREAS WHERE STRUCTURE HAS NOT ATTAINED ITS FULL DESIGN STRENGTH
- F. CONTRACTOR SHALL PROVIDE TEMPORARY SHORING AND BRACING AS REQUIRED FOR STABILITY B. OF STRUCTURAL MEMBERS AND SYSTEMS.
- G. CONTRACTOR SHALL BE RESPONSIBLE FOR PROTECTION OF ADJACENT PROPERTIES, STRUCTURES, STREETS, AND UTILITIES DURING CONSTRUCTION PERIOD.
- H. DETAILS NOTED AS TYPICAL ON DRAWINGS SHALL APPLY IN ALL SIMILAR CONDITIONS UNLESS SPECIFICALLY SHOWN OR NOTED. MODIFY DETAILS FOR SPECIAL CONDITIONS AS DIRECTED BY DESIGN PROFESSIONAL OF RECORD
- ALL ITEMS OF WORK SHOWN ARE NEW, UNLESS NOTED AS EXISTING.
- CONTRACTOR SHALL CONTACT STRUCTURAL HAWAII INC. PRIOR TO CONSTRUCTION. K. INSTALL SEALANT AT JOINTS WETHER SHOWN OR NOT ON DRAWINGS TO PROVIDE A WATERTIGHT INSTALLATION.
- L. THIS PROJECT SHALL BE CONSTRUCTED IN ACCORDANCE WITH AMERICANS WITH DISABILITIES ACT ACCESSIBILITY GUIDELINES.

<u>DESIGN CRITERIA</u>

A. DESIGN LIVE LOADS

FOUNDATIONS:

1. ROOF 2. FLOOR		20 PSF 40 PSF
1. SEISMI	RNATIONAL BUILDING CODE (IBC)—2012 EDITION) C: SEISMIC USE GROUP SOIL SITE CLASS SEISMIC DESIGN CATEGORY *SEISMIC RESPONSE COEFFICIENT *SPECTRAL RESPONSE COEFFICIENT	1 D D CS = 0.0805 SDS = 0.523
	*MAPPED SPECTRAL RESPONSE ACCELERATION *SOIL FACTOR COEFFICIENTS	SD1 = 0.244 SS = 0.591; S1 = 0.174 Fa = 1.327; Fv = 2.104
*	RUCTURAL SYSTEMLIGHT FRAMED WALLS WITH SHEAR PANELS RESPONSE MODIFICATION COEFFICIENT ANALYSIS PROCEDURE EQUIVALENT LATERAL FORCE	R=6.5
2. WIND:	EXPOSURE FACTOR \	130 MPH EXPOSURE "B" "R" GCpi = ±0.18

FOUNDATION/EXCAVATION/EARTHWORK:

ALLOWABLE SOIL BEARING PRESSURE

- A. FOUNDATIONS WERE DESIGN BASED ON ASSUMED GEOTECHNICAL PARAMETERS AS NO GEOTECHICAL SOILS INVESTIGATION REPORT WAS PREPARED OR AVAILABLE DURING DESIGN OF THIS PROJECT.
- FOOTINGS SHALL BEAR ON UNDISTURBED IN-SITU FIRM SOILS. BOTTOM OF FOOTING SHALL BE COMPACTED TO PROVIDE A RELIABLE, FIRM AND SMOOTH BEARING SURFACE PRIOR TO PLACEMENT OF REINFORCING STEEL AND CONCRETE. IF SOFT AND/OR LOOSE MATERIALS ARE ENCOUNTERED AT BOTTOM OF FOOTING EXCAVATIONS, POOR MATERIALS SHALL BE OVER-EXCAVATED TO EXPOSE UNDERLYING FIRM MATERIALS. OVER-EXCAVATION SHALL BE BACKFILLED WITH SELECT GRANULAR MATERIAL COMPACTED TO A MINIMUM OF 95% RELATIVE COMPACTION AT DETERMINED BY ASTM D1557 OR BOTTOM OF FOOTING MAY BE EXTENDED DOWN TO UNDERLYING COMPETENT MATERIAL
- C. FILL MATERIAL SHALL BE "NON-EXPANSIVE" IN CHARACTER, AND OF AN ACCEPTABLE GRADATION. ALL IMPORTED MATERIAL SHOULD HAVE A PLASTICITY INDEX NOT EXCEEDING 25 AND AT LEAST 20% OF PARTICLES SHOULD PASS NO. 100 SIEVE
- D. BACKFILL AROUND FOOTINGS AND FOUNDATIONS SHALL BE COMPACTED IN LAYERS BY PNEUMATIC TAMPER INTO A DENSE MASS. COMPACTED FILL SHALL CONSIST OF WELL GRADED CORAL, CRUSHED ROCK OR OTHER APPROVED MATERIAL. PLACE FILL IN 8" LOOSE LEVEL LIFTS AND COMPACT TO 90 PERCENT MINIMUM COMPACTION AS DETERMINED BY ASTM D1557.
- E. ALL EXCAVATIONS SHALL BE PROTECTED AND GUARDED BY CONTRACTOR AGAINST DANGER TO LIFE, LIMB AND PROPERTY. SHORING, SHEETING, CRIBBING AND LAGGING, AS REQUIRED TO PRESERVE EXCAVATIONS, EARTH BANKS AND ADJACENT STRUCTURES AND PROPERTY FREE FROM DAMAGE RESULTING FROM WORK SHALL BE PROVIDED AND INSTALLED BY CONTRACTOR. TONE AREA FOR UNDERGROUND UTILITIES PRIOR TO EXCAVATION.
- BACKFILL AGAINST BASEMENT WALLS AND PIT WALLS SUPPORTED AT TOP AND BOTTOM BY SLABS SHALL HAVE CURED FOR A MINIMUM OF 7 DAYS UNLESS WALLS ARE ADEQUATELY BRACED. FOR WALLS BACKFILLED ON BOTH SIDES, FILL MATERIAL SHALL BE PLACED IN SUCH A MANNER, THAT DIFFERENCE IN HEIGHT OF FILL SHALL NOT EXCEED TWO FEET AT ANY ONE
- H. FOUNDATIONS SHALL BE EMBEDDED 18 INCHES MINIMUM BELOW EXISTING GRADE.

CONCRETE

CONCRETE CONSTRUCTION SHALL CONFORM TO AMERICAN CONCRETE INSTITUTE ACI 318-11. B. ALL CONCRETE SHALL BE REGULAR WEIGHT CONCRETE AND SHALL DEVELOP THE MINIMUM 28-DAY COMPRESSIVE STRENGTHS OF 3000 PSI UNLESS NOTED OTHERWISE.

ELEMENTS	28 DAY STRENGTH (PSI) AGGREGATES	MAX. SIZE	SLUMP
1. FOOTINGS	3000	1 1/2"	3 1/2"±1/2"
2. SLABS-ON-GRADE	3000	3/4"	3 1/2"±1/2"
7 MICCELLANICOLIC	7000	7/1"	7 1 /2" 1 /2"

- 3. MISCELLANEOUS 3 1/2 ±1/2 ADMIXTURE USE SHALL BE AT CONTRACTOR'S OPTION, NOT SUBJECT TO ENGINEER'S **APPROVAL**
- CONCRETE DELIVERY TICKETS SHALL RECORD ALL FREE WATER IN MIX: AT BATCHING PLANT. FOR CONSISTENCY BY DRIVER, AND ANY ADDITIONAL REQUEST BY THE CONTRACTOR IF PERMITTED BY MIX DESIGN.
- E. ALL INSERTS, ANCHOR BOLTS, PLATES AND OTHER ITEMS TO BE CASE IN CONCRETE SHALL BE HOT-DIPPED GALVANIZED ACCORDING TO ASTM A153 UNLESS OTHERWISE NOTED.


- REINFORCING BARS, ANCHOR BOLTS, INSERTS, AND OTHER ITEMS TO BE CAST IN CONCRETE SHALL BE SECURED IN POSITION PRIOR TO PLACEMENT OF CONCRETE.
- G. CONDUITS. PIPES. AND SLEEVES PASSING THROUGH A SLAB OR FOOTING AND NOT CONFORMING TO TYPICAL DETAILS SHALL BE LOCATED AND SUBMITTED TO DESIGN PROFESSIONAL OF RECORD FOR APPROVAL
- CLEARANCES, DIMENSIONS, AND ELEVATIONS. CONTRACTOR SHALL COMPARE ALL CONTRACT H. CONDUITS, PIPES, AND SLEEVES EMBEDDED WITHIN A SLAB OR WALL (OTHER THAN THOSE PASSING THROUGH) SHALL BE: (1) NO LARGER IN OUTSIDE DIMENSION THAN 1/3 OVERALL SLAB OR WALL THICKNESS IN WHICH THEY ARE EMBEDDED; (2) PLACED IN MIDDLE 沒 OF SLAB OR WALL THICKNESS; AND (3) SPACED NO CLOSER THAN 3 DIAMETERS OR WIDTHS ON CENTER.
 - UNLESS OTHERWISE SHOWN, CONSTRUCTION JOINTS SHALL BE LOCATED BY CONTRACTOR(SUBJECT TO APPROVAL OF DESIGN PROFESSIONAL OF RECORD). JOINTS SHALL BE SO LOCATED AS TO LEAST IMPAIR STRENGTH OF STRUCTURE AND TO MINIMIZE SHRINKAGE STRESSES. PROVIDE DOWELS AS DIRECTED AND THOROUGHLY CLEAN AND ROUGHEN SURFACES BEFORE PROCEEDING WITH NEXT POUR (THIS REQUIREMENT APPLIES TO FLOORS AND WALLS).
 - SEE ARCHITECTURAL DRAWINGS FOR CHAMFERS, EDGE RADII, DRIPS, REGLETS, FINISHES, AND OTHER NON-STRUCTURAL ITEMS NOT SHOWN OR SPECIFIED ON STRUCTURAL DRAWINGS
 - NON-SHRINK GROUT SHALL BE A PREMIXED NON-METALIC FORMULA CAPABLE OF DELIVERING A MINIMUM COMPRESSIVE STRENGTH OF 3,000 PSI IN 1 DAY AND 5,000 PSI IN 28 DAYS. CONTRACTOR TO USE A WATER TO CEMENT RATIO OF 0.5 OR LESS UNLESS OTHERWISE
 - SPECIFIED BY A LICENSED ENGINEER.

4. WELDED WIRE FABRIC

- ALL REINFORCING BARS SHALL BE DEFORMED BARS CONFORMING TO ASTM A615, GRADE 60. STIRRUPS AND TIES SHALL BE GRADE 60.
- MINIMUM CONCRETE CLEAR COVER FOR REINFORCING BAR, UNLESS OTHERWISE NOTED: CONCRETE CAST AGAINST AND PERMANENTLY EXPOSED TO EARTH 3"
- CONCRETE EXPOSED TO EARTH OR WEATHER CONCRETE NOT EXPOSED TO WEATHER OR IN CONTACT WITH GROUND:
- SLABS, WALLS, JOISTS BEAMS, COLUMNS (TO TIES, STIRRUPS, SPIRALS) 1-1/2"
- ALL OTHER CONDITIONS REBAR POSITIONERS OR "CHAIRS SHALL BE USED TO MAINTAIN REQUIRED MINIMUM CONCRETE CLEAR COVER FOR ALL BEAM, COLUMN, AND WALL REINFORCING AT FACES AT EXPOSED TO WEATHER.
- BAR BENDS AND HOOKS SHALL BE "STANDARD HOOKS" IN ACCORDANCE WITH ACI 318.
- REINFORCING STEEL SHALL BE SPLICED WHERE INDICATED ON PLANS. PROVIDE LAP SPLICE LENGTH PER TYPICAL DETAILS AND SCHEDULE, UNLESS OTHERWISE NOTED.

	MIN	IMUM SPLICE &	& EMBEDMENT LE	ENGTHS		
	LAP S	PLICE	EMBEDMENT			
			STRA			
BAR SIZE	BOTTOM BAR OR WALL BAR	TOP BAR	BOTTOM BAR OR WALL BAR	TOP BAR	WITH STANDARD HOOK	
#3, #4	24"	30"	18"	24"	12"	
#5	30"	38"	22"	30"	14"	
#6	36"	46"	28"	36"	18"	
#7	50"	66"	40"	50"	20"	

<u>NOTES:</u> (1) LENGTHS ARE FOR CONCRETE WITH REBAR SPACED 6 BAR DIAMETERS MINIMUM. INCREASE 25% FOR BARS SPACED LESS THAN 6 BAR DIAMETERS. (2) "TOP BARS" ARE HORIZONTAL BARS WITH 12" OR MORE OF CONCRETE CAST BELOW.

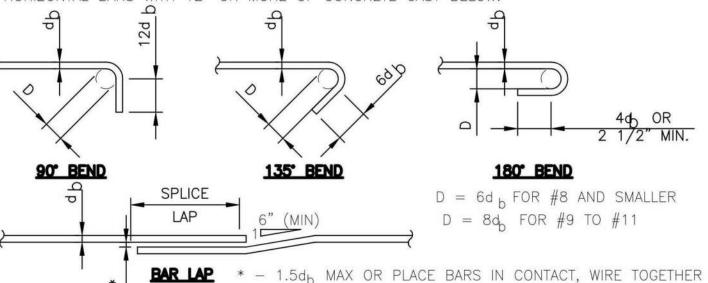

<u>LUMBER:</u>

1500 PSF

- LUMBER SHALL BE TERMITE AND ROT PRESSURE PRESERVATIVE TREATED COASTAL DOUGLAS FIR CONFORMING WITH STANDARD GRADING AND DRESSING RULES OF WEST COAST LUMBER INSPECTION BUREAU (WCLIB).
- UNLESS OTHERWISE NOTED, STRUCTURAL MEMBERS SHALL HAVE FOLLOWING GRADES OR BETTER: 2X4 STUDS. ..STUD GRADE
- 2X6 STUDS. ..GRADE NO. 2 JOISTS AND RAFTERS. .GRADE NO. 2 4X HEADERS. ..GRADE NO.
- 4X POSTS.. ..GRADE NO. SHEATHING SHALL BE INDENTIFIED WITH APPROPRIATE TRADEMARK OF AMERICAN PLYWOOD ASSOCIATION, AND SHALL MEET REQUIREMENTS OF LATEST EDITION OF U.S. PRODUCT STANDARD
- ROOF SHEATHING SHALL BE & CDX APA RATED SHEATHING, EXPOSURE 1, 32/16 SPAN RATING. INTERIOR WALL SHEATHING SHALL BE STR. 1 APA RATED SHEATHING, EXPOSURE 1, 16" O.C. SPAN
- RATING. FLOOR SHEATHING SHALL BE 3/4" CDX APA RATED SHEATHING, EXPOSURE 1, 48/24 SPAN RATING.
- INTERIOR GYPSUM WALL SHEATHING SHALL BE 5/8" THICK, TYPE "X". EXTERIOR WALL SHEATHING SHALL BE STR. 1 APA RATED SIDING SHEATHING, EXTERIOR EXPOSURE, 16" O.C. SPAN RATING.
- PROVIDE MINIMUM NAILING PER TABLE 23-II-B-1 OF 2006 IBC. (SEE SCHED. BELOW)
- NAILS SHALL BE GALVANIZED COMMON NAILS.

SOLID BLOCKING TO JOIST

PS1 OR APA'S PERFORMANCE STANDARDS.

BOLTS SHALL CONFORM TO ASTM A307. PREFABRICATED FRAMING HARDWARE SHALL BE SIMPSON STRONG TIE, GALVANIZED, OR APPROVED EQUAL. INSTALL PER MANUFACTURER'S RECOMMENDATIONS.

4-8d


- H. PLACE A LAYER OF 30# ROOFING FELT BETWEEN ALL WOOD MEMBERS AND CONCRETE OR MASONRY SURFACES. MINIMUM NAILING SCHEDULE:
- CONNECTION COMMON NAILING JOIST TO TOP PLATE OR GIRDER, TOE NAIL 3 - 8d2-8d BRIDGING TO JOIST, TOE NAIL EACH END SOLE PLAT TO JOIST OR BLCKING, FACE NAIL 16d@16"0.C. 4 - 8dSTUD TO SOLE PLATE, TOE NAIL DOUBLE TOP PLATE: DOUBLE TOP PLATE: LOWER PLATE TO STUD, FACE NAIL 2 - 20dUPPER PLATE TO LOWER PLATE, FACE NAIL 16d@16"0.C. TOP PLATE, LAPS AND INTER., FACE NAIL 2-16d 3-8d RAFTER (OR TRUSS) TO PLATE, TOE NAIL BUILT-UP CORNER STUDS 16d@36"0.C. CONT. HEADER TO STUD. TOE NAIL 4-8d


GLUED LAMINATED TIMBER:

- A. ALL MATERIALS, FABRICATIONS, AND QUALITY CONTROL SHALL CONFORM TO AMERICAN
- NATIONAL STANDARD ANSI/AITC A190.1. B. GLUED LAMINATED TIMBER SHALL BE TERMITE AND ROT PRESSURE TREATED DOUGLAS
- C. SIMPLE SPAN GLUED LAMINATED TIMBER SHALL BE 24F-V4 WITH 1,600 FOOT RADIUS CAMBER.
- D. CANTILEVER OR CONTINUOUS GLUED LAMINATED TIMBER SHALL BE 24F-V4 WITH
- CAMBER AS SHOWN ON DRAWINGS.
- ADHESIVE SHALL BE FOR WET CONDITION OF USE. EXPOSED OR PARTIALLY EXPOSED MEMBERS SHALL
- BE ARCHITECTURAL APPEARANCE GRADE. CONCEALED MEMBERS SHALL BE INDUSTRIAL APPEARANCE GRADE

<u>SPECIAL INSPECTION:</u>

- CONTRACTOR SHALL BE RESPONSIBLE FOR ENSURING THAT SPECIAL INSPECTION OF PORTIONS OF WORK, AS REQUIRED BY LOCALLY ADOPTED CURRENT BUILDING CODE, BE MADE AT APPROPRIATE TIME. CONTRACTOR SHALL GIVE TIMELY NOTICE (48 HOURS MINIMUM) OF WHEN AND WHERE INSPECTIONS ARE TO BE MADE AND PROVIDE ACCESS FOR INSPECTOR. CONTRACTOR SHALL CORRECT DEFECTIVE WORK AT NO ADDITIONAL COST TO OWNER AND PAY
- FOR RE-INSPECTION. SPECIAL INSPECTOR SHALL BE HIRED BY OWNER. B. THE FOLLOWING STRUCTURAL WORK FOR THIS PROJECT REQUIRE SPECIAL INSPECTIONS 16. SHEATHED SHEAR WALLS AND DIAPHRAGMS
- 17. COMPLETE LOAD PATH AND UPLIFT TIES C. SPECIAL INSPECTION IS NOT REQUIRED FOR FOUNDATION CONCRETE AND REINFORCING STEEL.
- FOUNDATIONS WERE DESIGNED WITH f'c = 2,500 PSI. D. SPECIAL INSPECTION IS NOT REQUIRED FOR BOLTS INSTALLED IN CONCRETE. EMBEDDED BOLTS
- WERE DESIGNED WITHOUT STRESS INCREASES. E. SPECIAL INSPECTION IS NOT REQUIRED FOR CMU. CMU HAS BEEN DESIGNED USING ALLOWABLE
- STRESS DESIGNED WITHOUT SPECIAL INSPECTION. F. SPECIAL INSPECTIONS DO NOT RELIEVE GENERAL CONTRACTOR OF HIS RESPONSIBILITIES TO COMPLETE THE PROJECT IN ACCORDANCE WITH CONSTRUCTION DOCUMENTS AND TO BE
- RESPONSIBLE FOR SAFETY ON JOBSITE. G. SPECIAL INSPECTOR SHALL SUBMIT A FINAL REPORT TO BUILDING DEPARTMENT, STATING WHETHER WORK REQUIRING SPECIAL INSPECTION WAS, TO BEST OF HIS/HER KNOWLEDGE. IN CONFORMANCE WITH CONSTRUCTION DOCUMENTS AND APPLICABLE WORKMANSHIP PROVISIONS OF
- BUILDING CODE. SUBMITTALS TO ARCHITECT, STRUCTURAL ENGINEER AND OWNER ARE OPTIONAL H. NOTIFY BUILDING INSPECTOR, SPECIAL INSPECTOR, AND DESIGN PROFESSIONAL OF RECORD AT LEAST 48 HOURS PRIOR TO EACH DESIRED INSPECTION:
 - 1. FOUNDATION/SLAB INSPECTION: TERMITE TREATMENT CERTIFICATE; AFTER FOOTING EXCAVATIONS ARE COMPLETE AND REQUIRED REINFORCING STEEL FORMS ARE IN PLACE; AFTER ALL IN-SLAB OR UNDER-FLOOR ANCILLARY ITEMS ARE IN PLACE.
 - 2. FRAME INSPECTION: AFTER ROOF, ALL FRAMING, FIRE BLOCKING, BRACING, AND METAL CONNECTORS ARE IN PLACE; ALL PIPES, CHIMNEYS AND VENTS ARE COMPLETED; AND ROUGH ELECTRICAL, PLUMBING OR MECHANICAL INSTALLATIONS ARE APPROVED

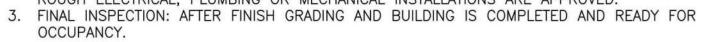

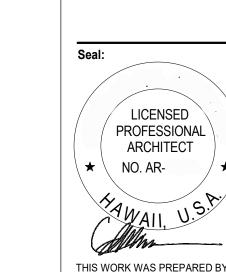

〒

(ENA 3702)

912 IK

 \circ

ENA

2

0

ME OR UNDER MY SUPERVISION AND CONSTRUCTION OF THIS PROJECT WILL BE UNDER MY OBSERVATION. EXPIRATION DATE: 04/30/2024

Issue Dates:


Description

Drawn By: Author

Scale:

06/20/2023

STRUCTURAL NOTES

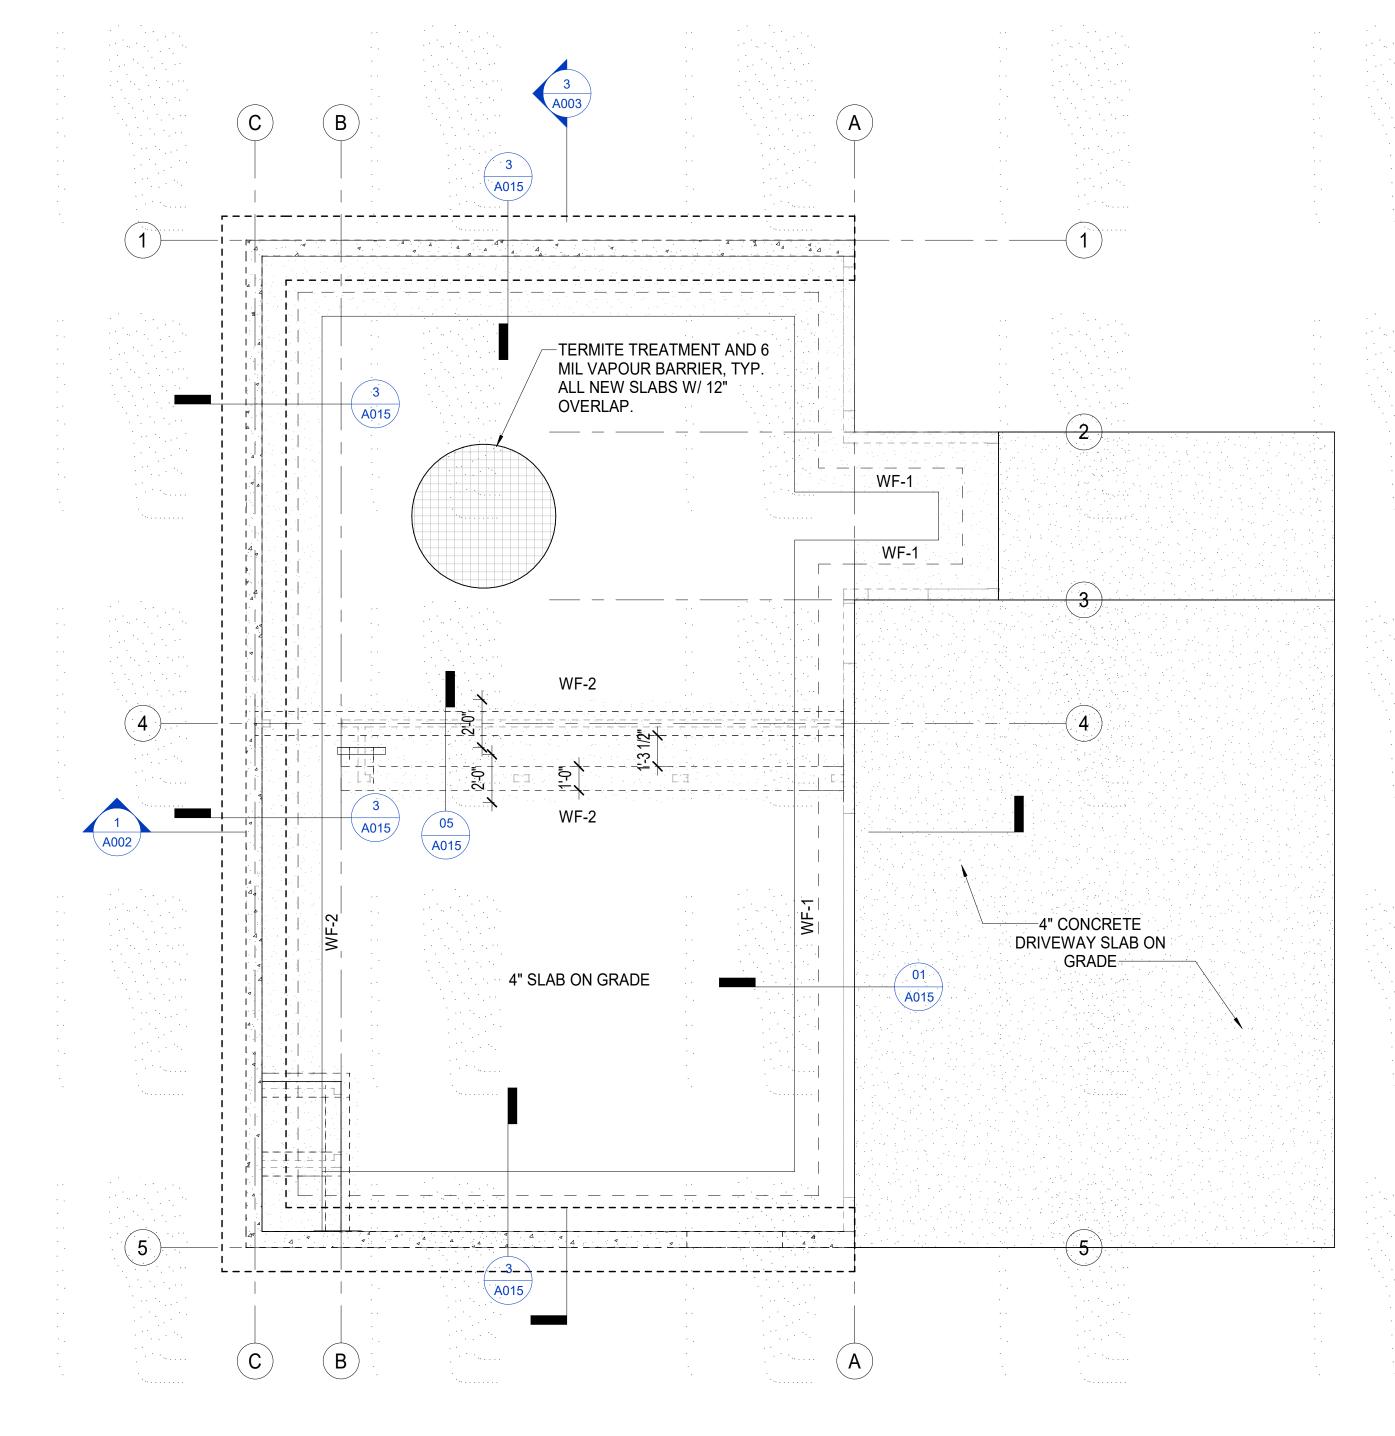

OUNDATION PLAN

1/4" = 1'-0"

0 2' 4' 8'

TRUE NORTH

S001

FOUNDATION

王

912 IKENA CIR, I **TMK: 37020030**

PROFESSIONAL ARCHITECT

ME OR UNDER MY SUPERVISION AND CONSTRUCTION OF THIS PROJECT WILL BE UNDER MY

EXPIRATION DATE: 04/30/2024

Date Description

★ \ NO. AR-

OBSERVATION.

Issue Dates:

Drawn By:
Author

Scale:

As indicated


06/20/2023

PLAN

CIRCL

IKENA

912

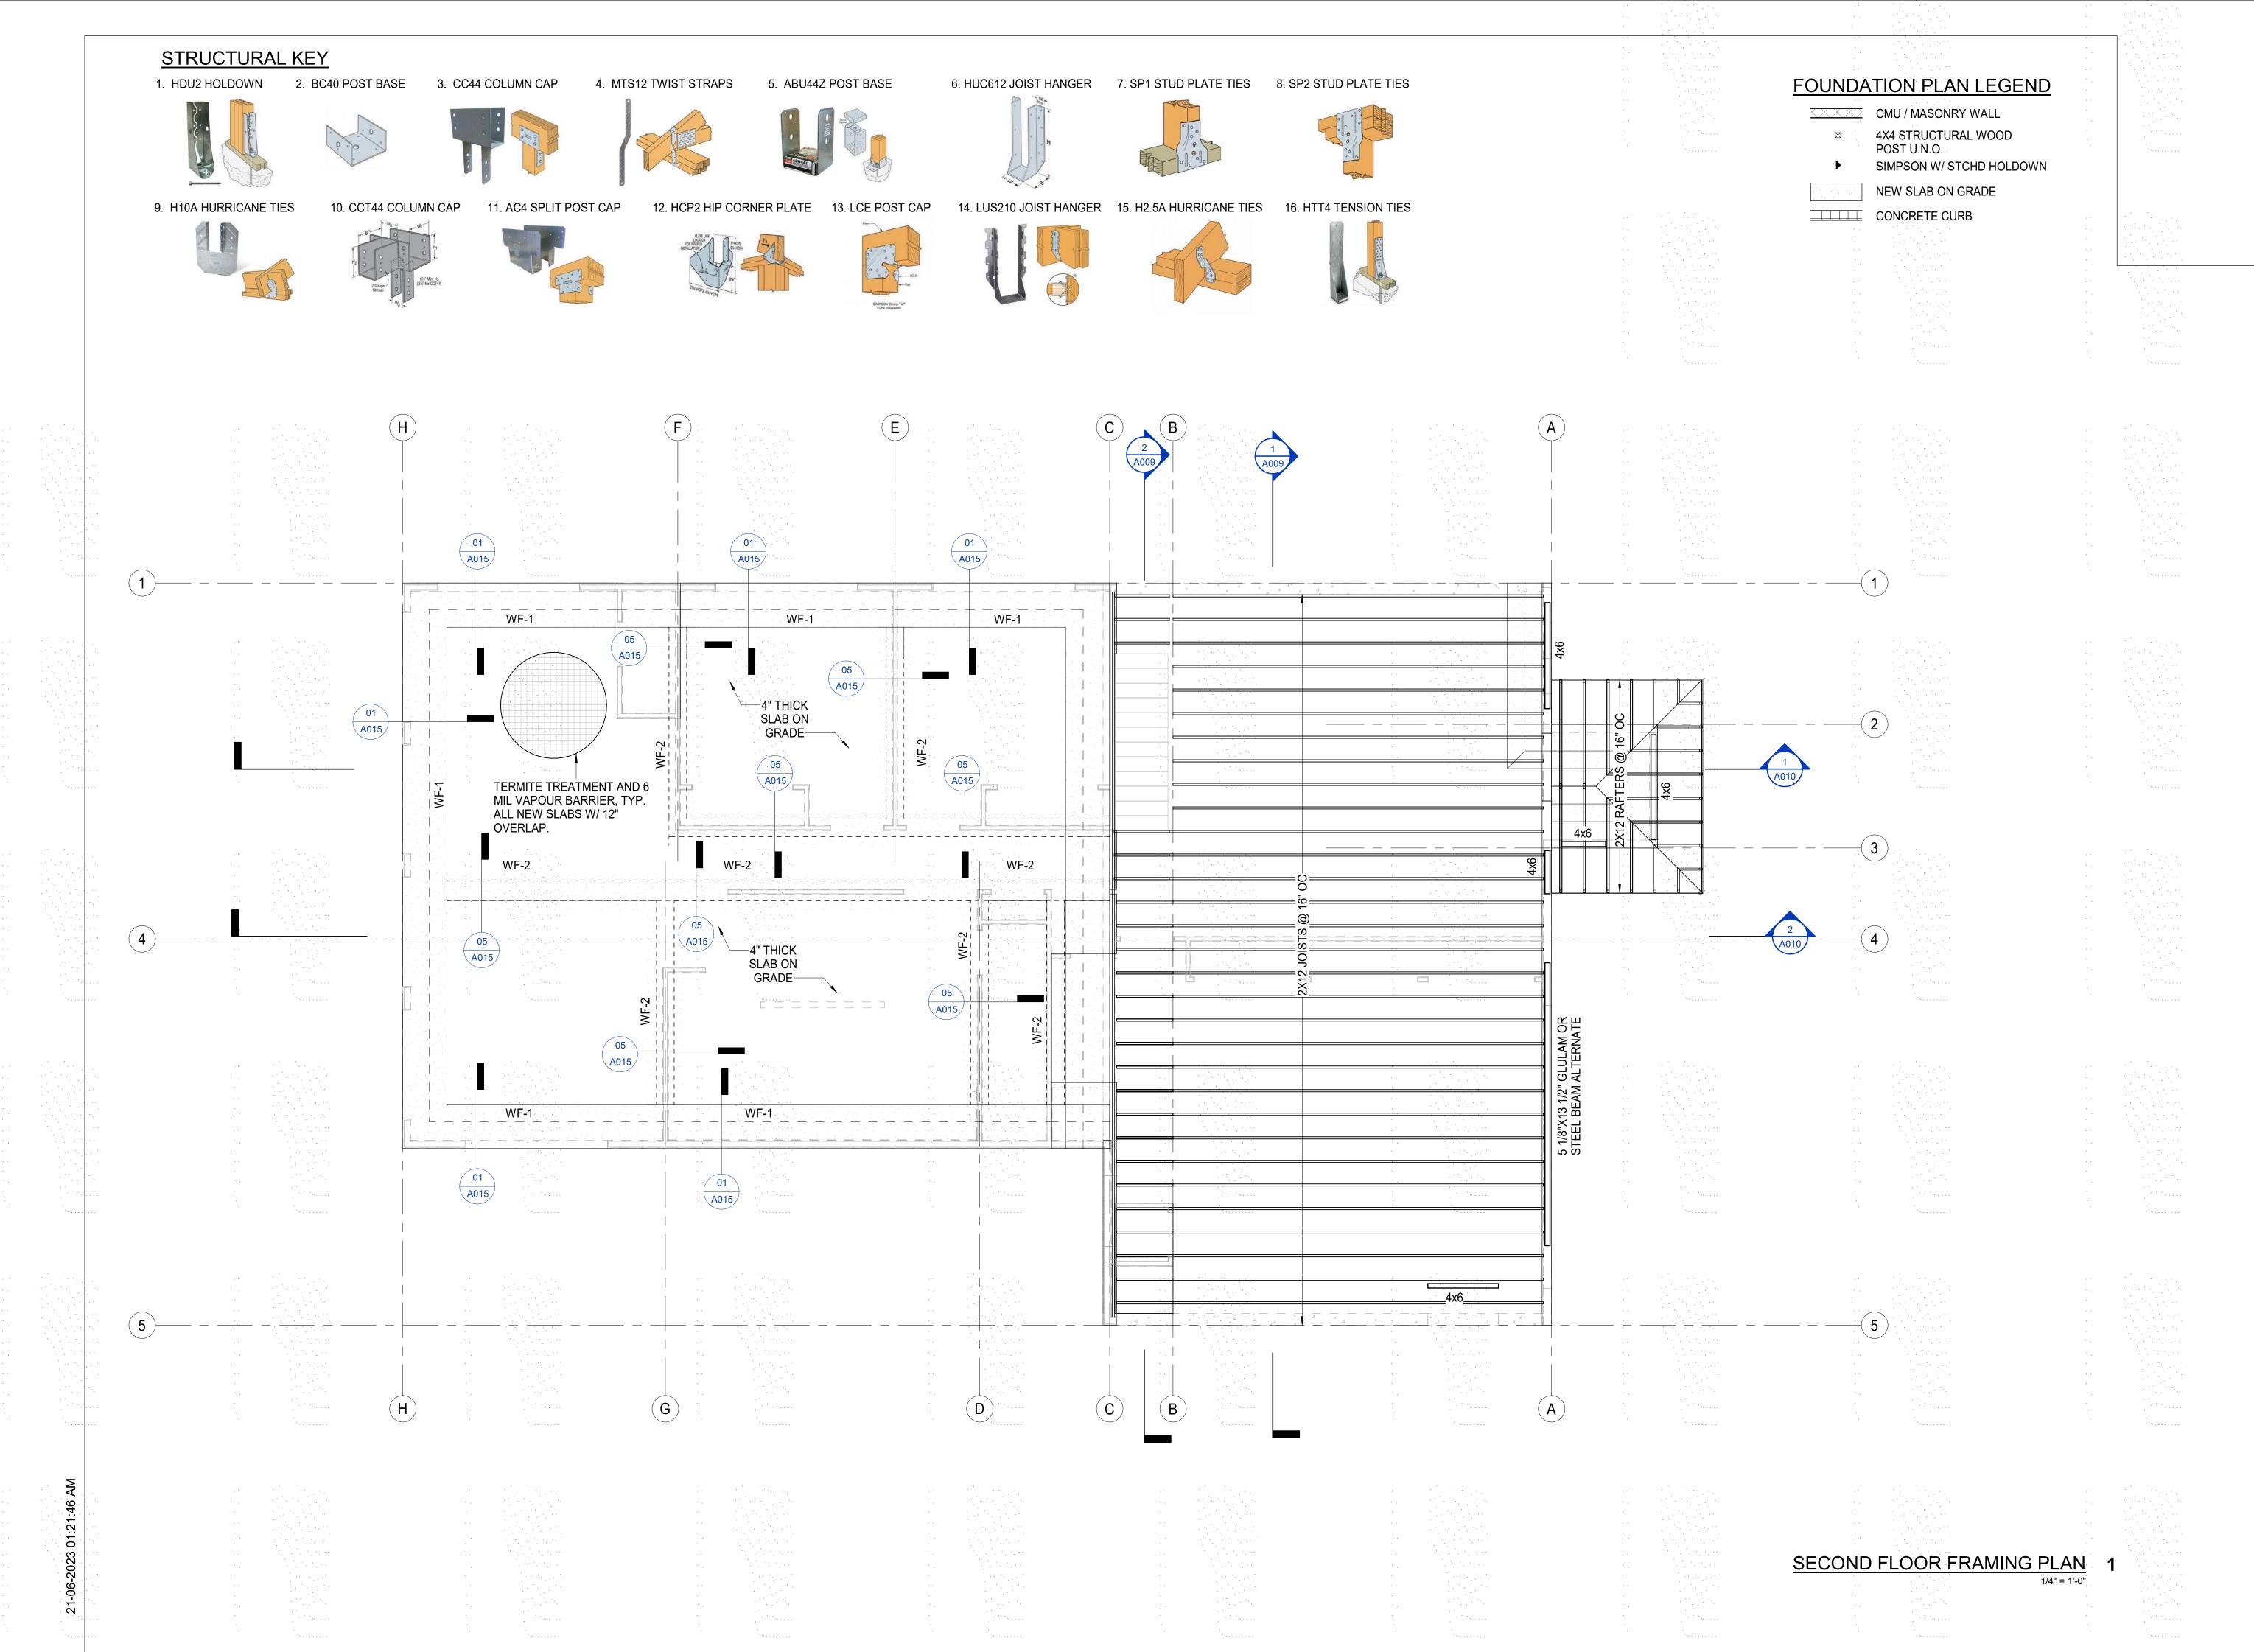

912 IKENA CIRCLE

王

912 IKENA CIR, F TMK: 37020030

Seal:

LICENSED
PROFESSIONAL
ARCHITECT
NO. AR
THIS WORK WAS PREPARED BY
ME OR UNDER MY SUPERVISION
AND CONSTRUCTION OF THIS
PROJECT WILL BE UNDER MY
OBSERVATION.

EXPIRATION DATE: 04/30/2024

Issue Dates:

Date Description

Drawn By:
Author


As indicated

Date:

06/20/2023

SECOND FLOOR FRAMING PLAN

S002

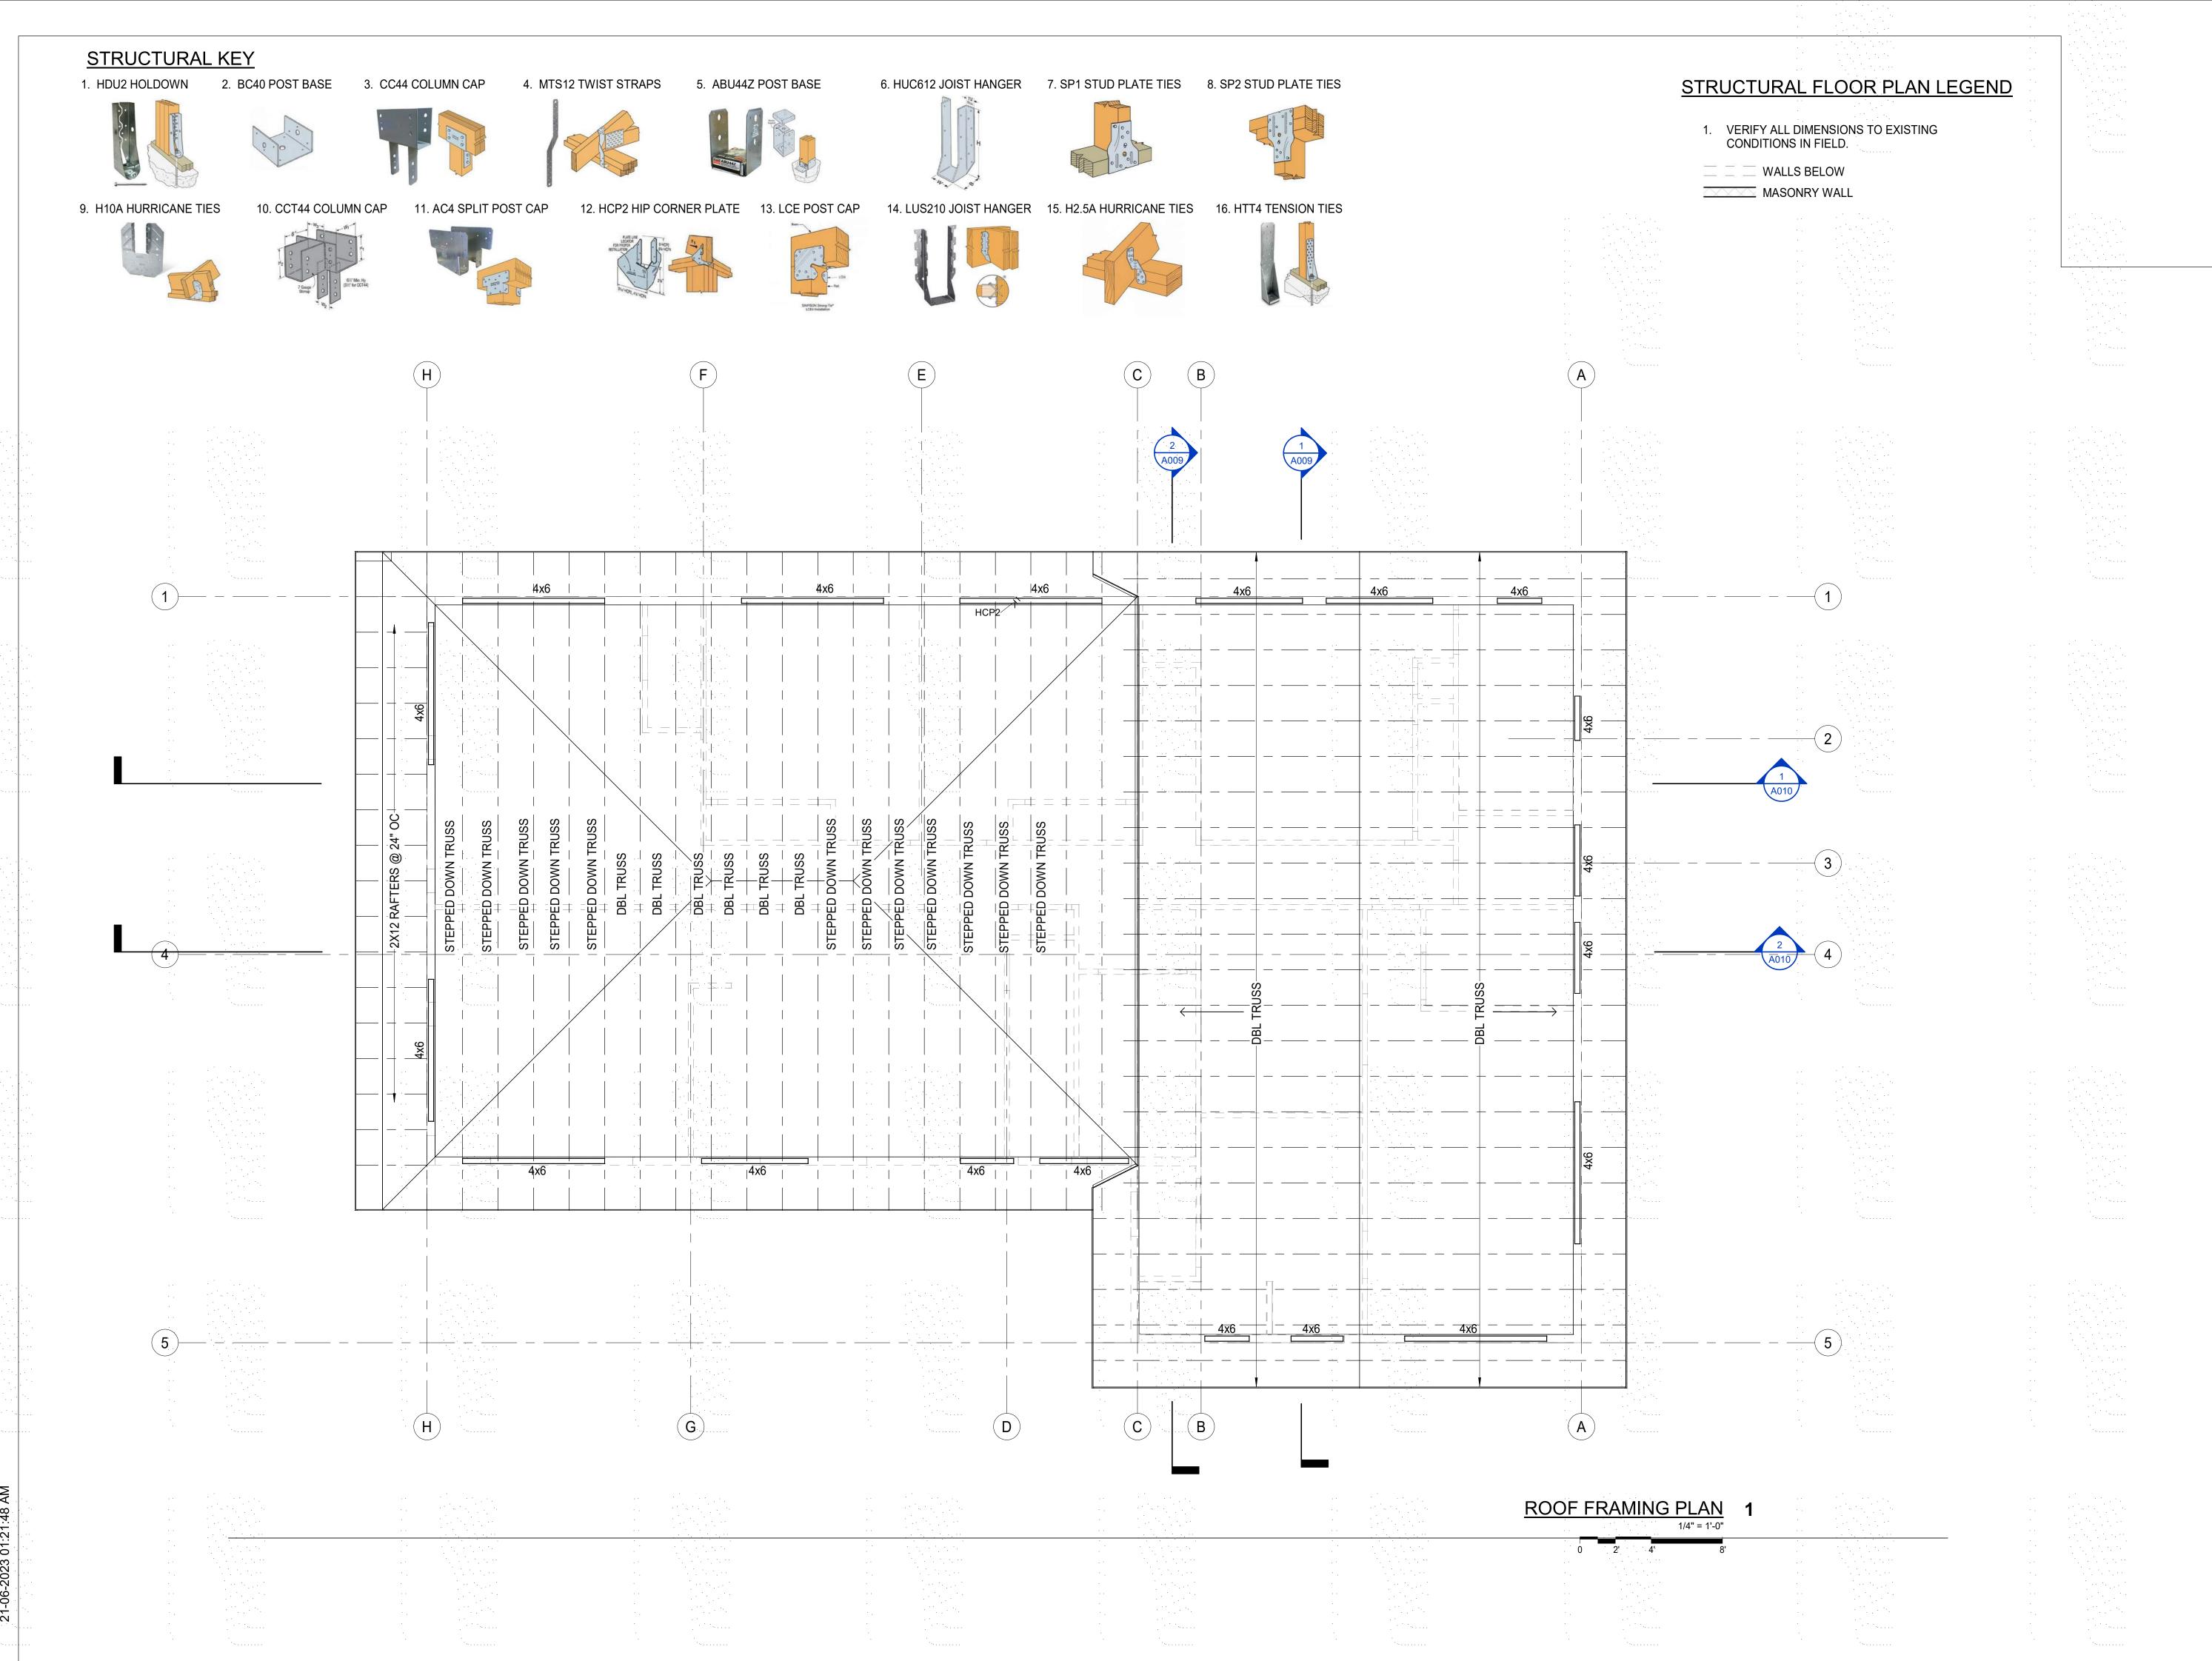

TRUE NORTH

S003

CIRCLE

912 IKENA

912 IKENA CIR, F TMK: 37020030

LICENSED PROFESSIONAL ARCHITECT

THIS WORK WAS PREPARED BY ME OR UNDER MY SUPERVISION AND CONSTRUCTION OF THIS

PROJECT WILL BE UNDER MY OBSERVATION. EXPIRATION DATE: 04/30/2024

Date Description

Issue Dates:

Drawn By:
Author
Scale:

As indicated

06/20/2023

ROOF

PLAN

FRAMING

★ NO. AR-